CANMORE CEMETERY - FINAL DESIGN AND NEW COLUMBARIUM **ISSUED FOR TENDER**



LANDSCAPE DRAWING LIST

- Drawing # Drawing Title
- COVER SHEET L0.0
- L1.0 EXISTING CONDITIONS L2.0
- DEMOLITIONS + REMOVAL PLAN L3.0 SITE + MATERIALS PLAN
- L4.0 LAYOUT PLAN
- PLANTING PLAN L5.0
- L6.0 DETAILS- PLANTING
- DETAILS- SURFACES L7.0
- DETAILS- BOULDER RETAINING WALL L7.1
- L7.2 DETAILS- COLUMBARIA
- L7.3 DETAILS- FURNISHINGS
- L8.0 IRRIGATION PLAN
- L8.1 DETAILS- IRRIGATION
- L8.2 **DETAILS- IRRIGATION**

CIVIL DRAWING LIST			
DRAWING #	DRAWING TITLE		
C-100 SURFACE WORKS AND GRADING PLAN - CREMATION GARDEN			
STRUCTURAL DRAWING LIST			
S-100	GENERAL NOTES AND COLUMBARIUM FDN DETAILS		

NOTES:


GENERAL WORKMANSHIP

- 1. CONTRACTOR TO CONFIRM ALL UTILITY SERVICES BEFORE PROCEEDING WITH ANY WORK. CONTRACTOR SHALL INDEPENDENTLY VERIFY UTILITY LOCATIONS, SIZE AND TYPE.
- 2. NOTIFY THE OWNER'S REPRESENTATIVE OF ANY DISCREPANCIES. OBTAIN WRITTEN APPROVAL FROM THE OWNER'S REPRESENTATIVE PRIOR TO COMMENCING WORK.
- 3. COLLECT AND DISPOSE OF ALL DEBRIS AND/OR EXCESS MATERIAL FROM LANDSCAPE OPERATIONS. KEEP SURFACES CLEAN AND REPAIR ANY DAMAGE RESULTING FROM LANDSCAPE WORK. ALL REPAIR COSTS ARE THE CONTRACTORS' RESPONSIBILITY.
- 4. CONFIRM WITH THE OWNER'S REPRESENTATIVE PRIOR TO COMMENCING WORK TO CONFIRM WHEN SITE INSPECTION VISITS WILL BE CARRIED OUT.
- 5. CONTRACTOR SHOULD BE FAMILIAR WITH THE CANMORE ENGINEERING DESIGN AND CONSTRUCTION GUIDELINES. CONTRACTOR TO REFERENCE THE CANMORE ENGINEERING DESIGN AND CONSTRUCTION GUIDELINES FOR THE FOLLOWING:
 - A. WARRANTY PERIOD AND MAINTENANCE REQUIREMENTS B. CONSTRUCTION MANAGEMENT
 - C. SITE PREPARATION, GRADING, TOPSOIL, SEEDING AND SODDING D. PLANT MATERIAL
- E. IRRIGATION SYSTEMS 6. NO FOOD WASTE ALLOWED IN DUMPSTERS. BEAR PROOF CONTAINERS SUPPLIED BY TOWN MUST BE USED.


RESPECTFUL BEHAVIOR


- 1. CONTRACTORS AND THEIR STAFF, SUPPLIERS AND SUBTRADES MUST BE AWARE THAT THEY ARE WORKING WITHIN A FUNCTIONING CEMETERY AND THAT VISITATIONS MAY BE TAKING PLACE DURING THE COURSE OF CONSTRUCTION AT THE SITE. RESPECTFUL BEHAVIOR IS EXPECTED AT ALL TIME. CONSTRUCTION ACTIVITIES MUST NOT IMPEDE VEHICLE OR PEDESTRIAN MOVEMENT DURING GRAVE VISITATIONS.
- 2. CONTRACTOR STOP ALL WORK WHEN AN INTERMENT IS IN PROGRESS FOR "RESPECTFUL MOURNING". TOWN TO GIVE A MINIMUM OF 72 HOURS NOTICE.


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509-318 Homer Street Vancouver British Columbia Canada V6B 2V2 Tel: (604) 899-3806 Web: www.elac.ca Email: info@elac.ca

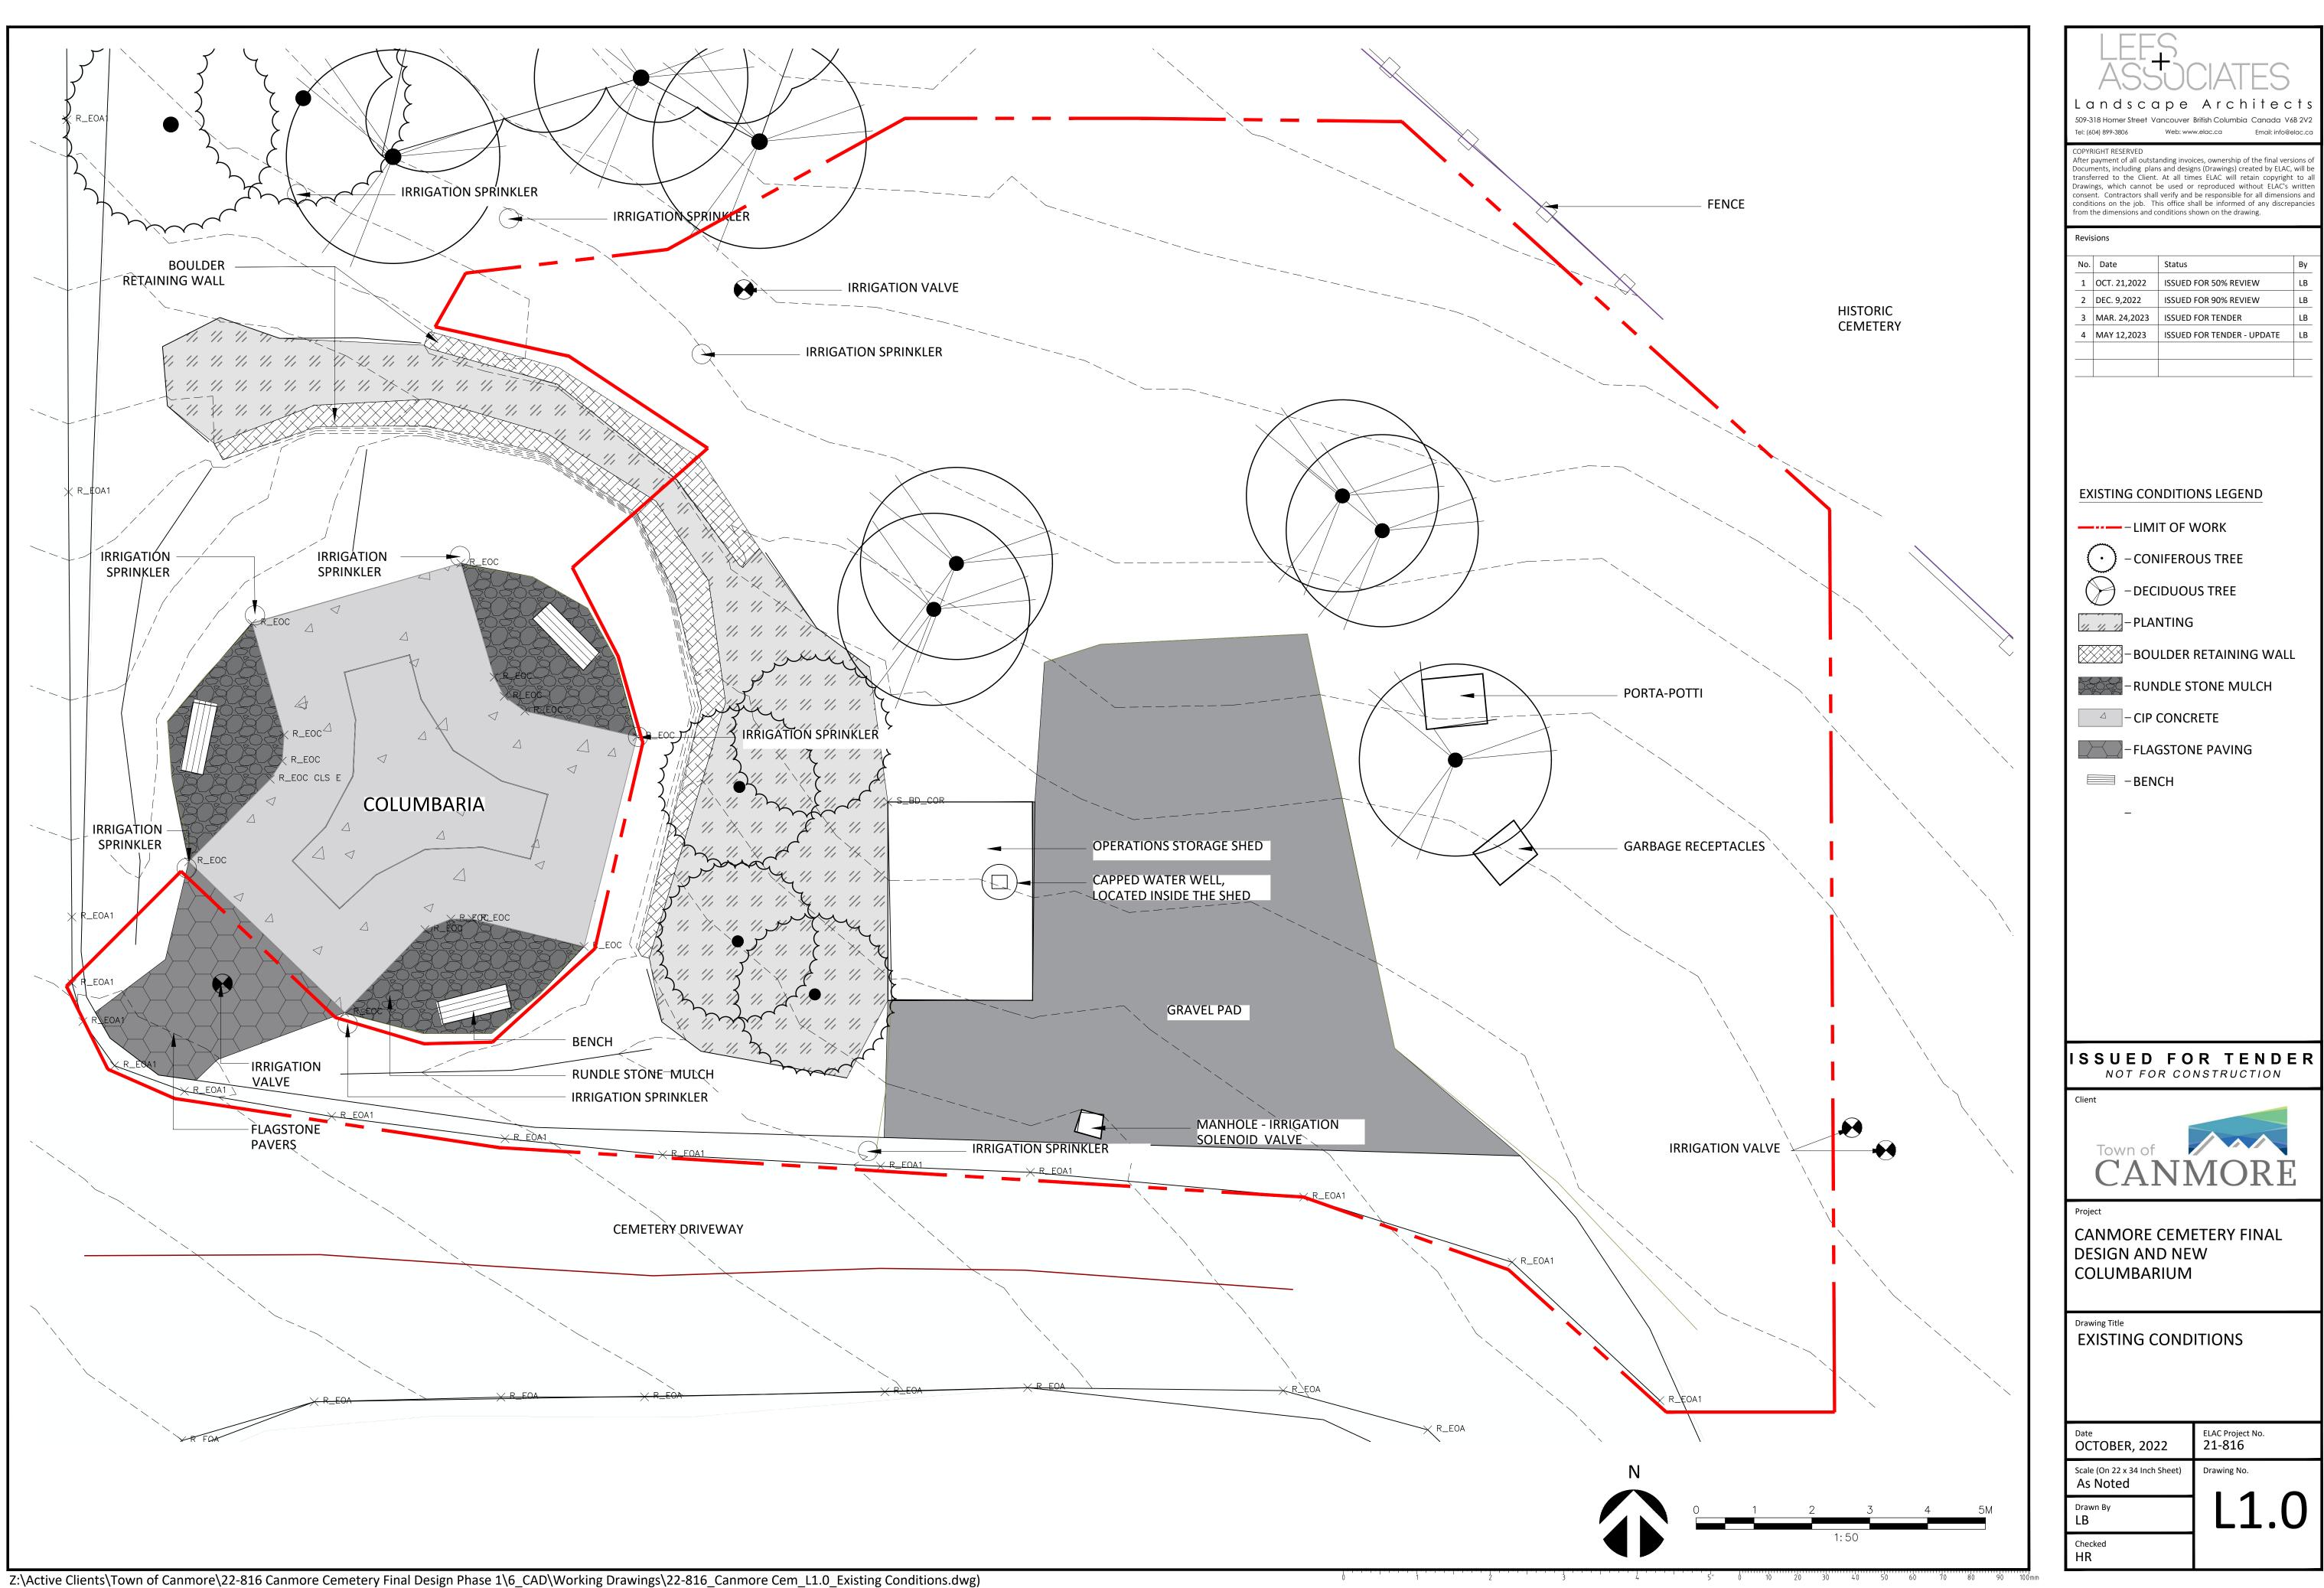
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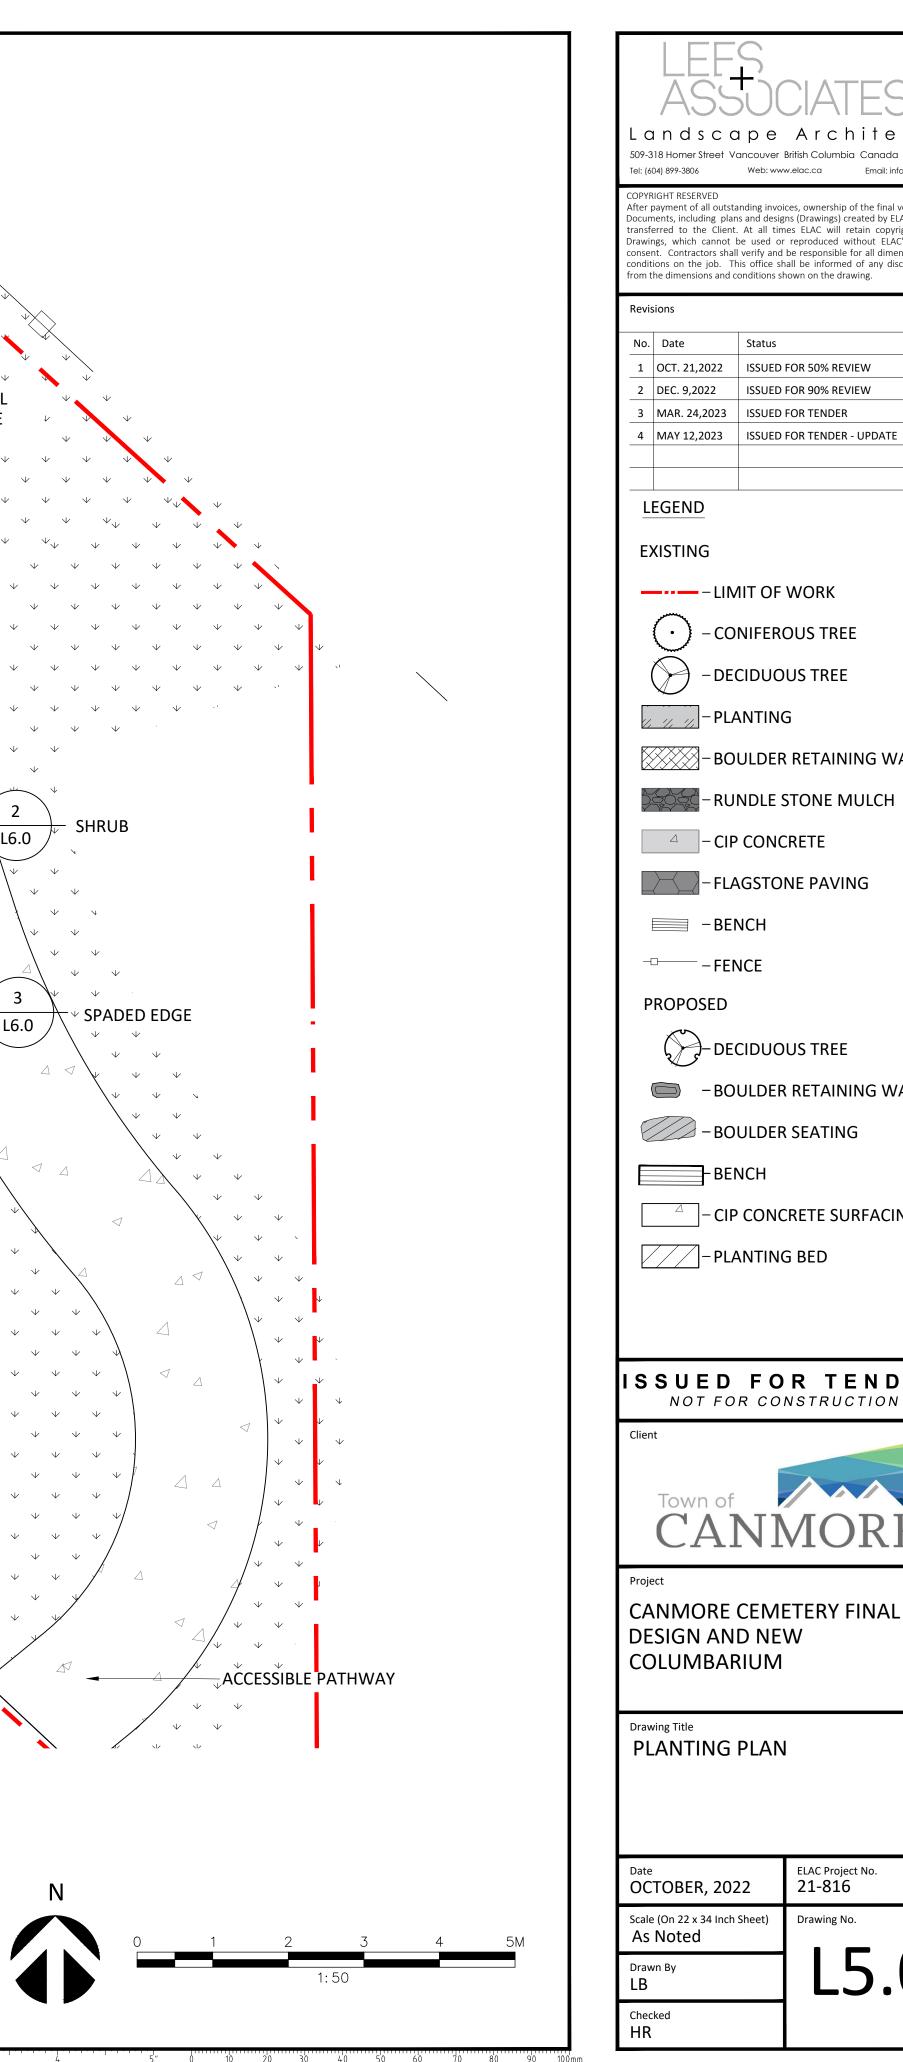
Drawings, which cannot be used or reproduced without ELAC's written consent. Contractors shall verify and be responsible for all dimensions and conditions on the job. This office shall be informed of any discrepancies from the dimensions and conditions shown on the drawing.

No.	Date	Status	Ву
1	OCT. 21,2022	ISSUED FOR 50% REVIEW	LB
2	DEC. 9,2022	ISSUED FOR 90% REVIEW	LB
3	MAR. 24,2023	ISSUED FOR TENDER	LB
4	MAY 12,2023	ISSUED FOR TENDER - UPDATE	LB

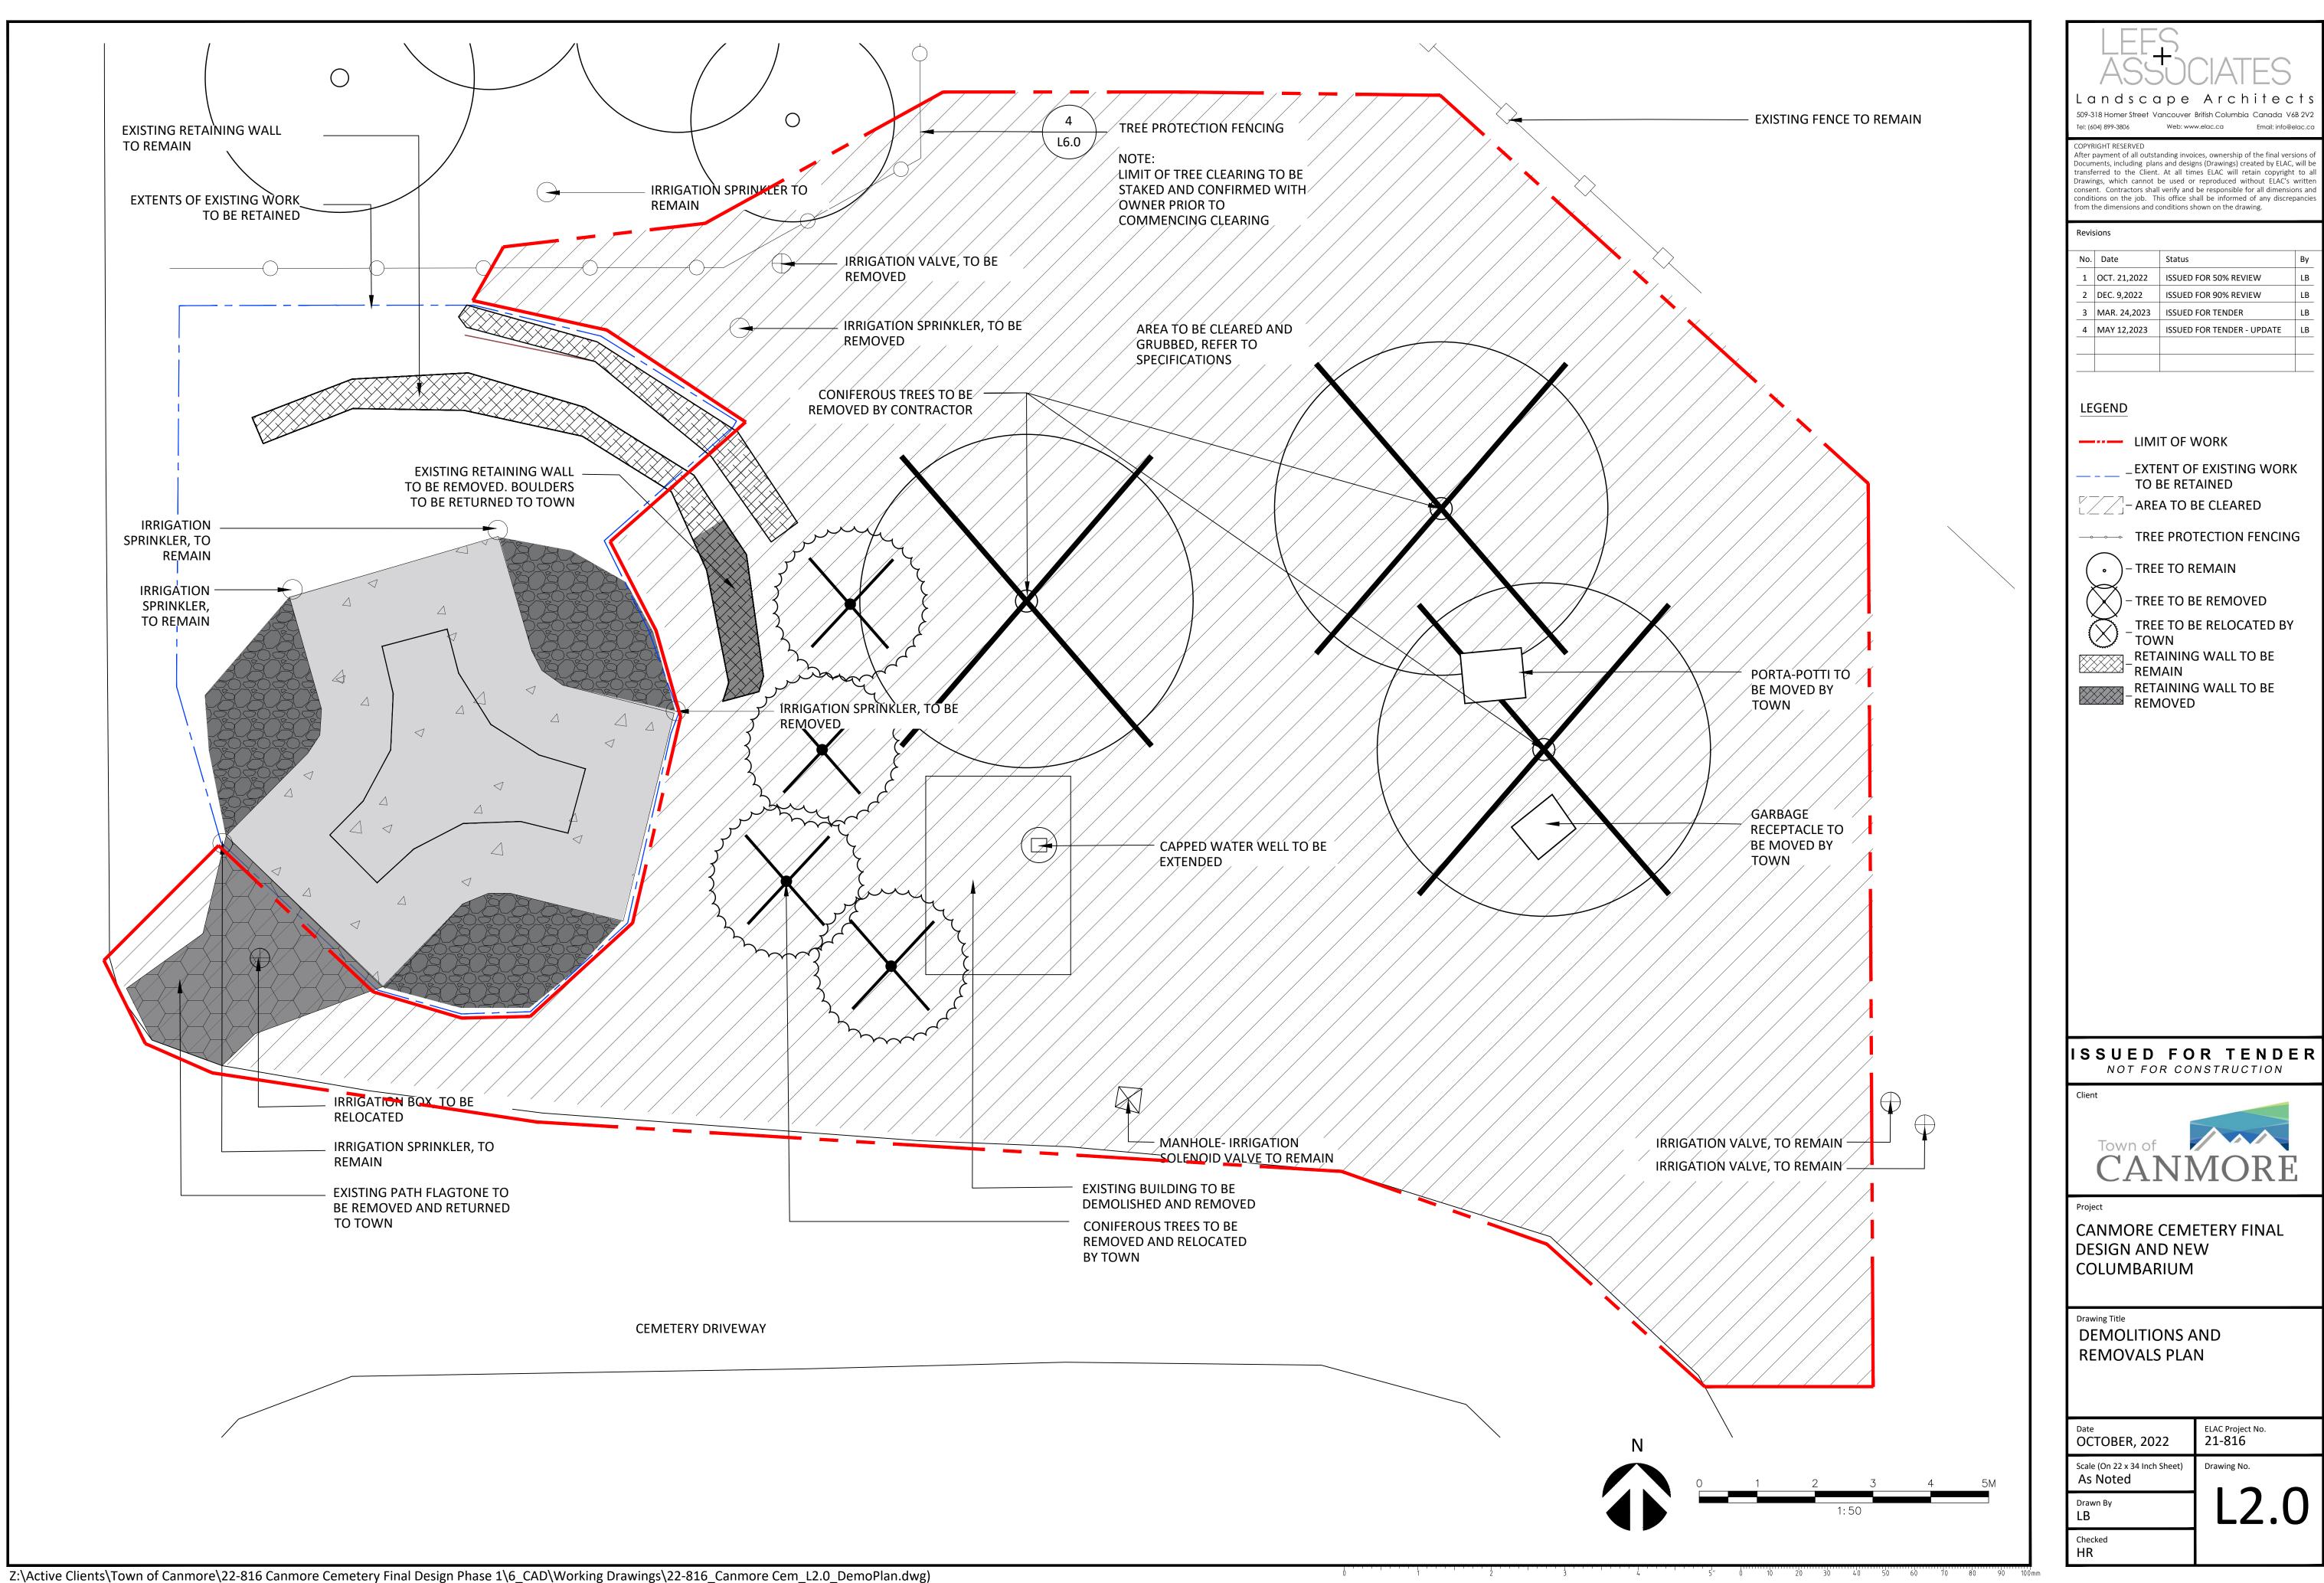
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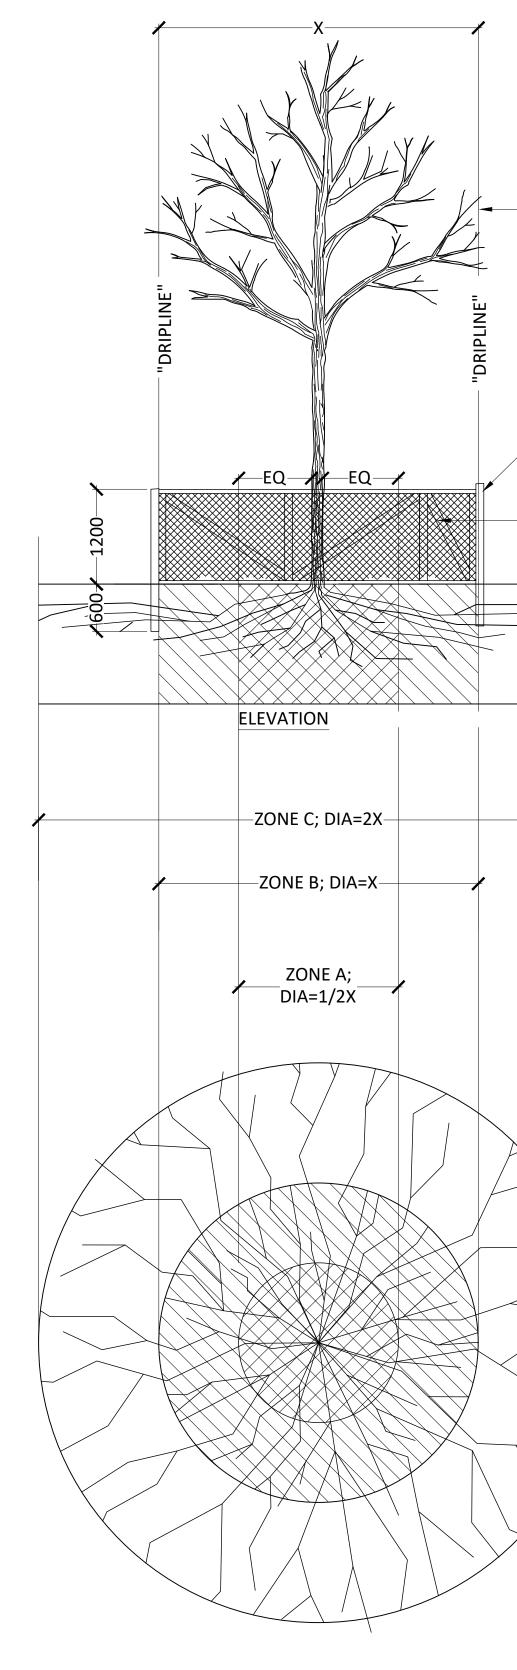
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PLAN

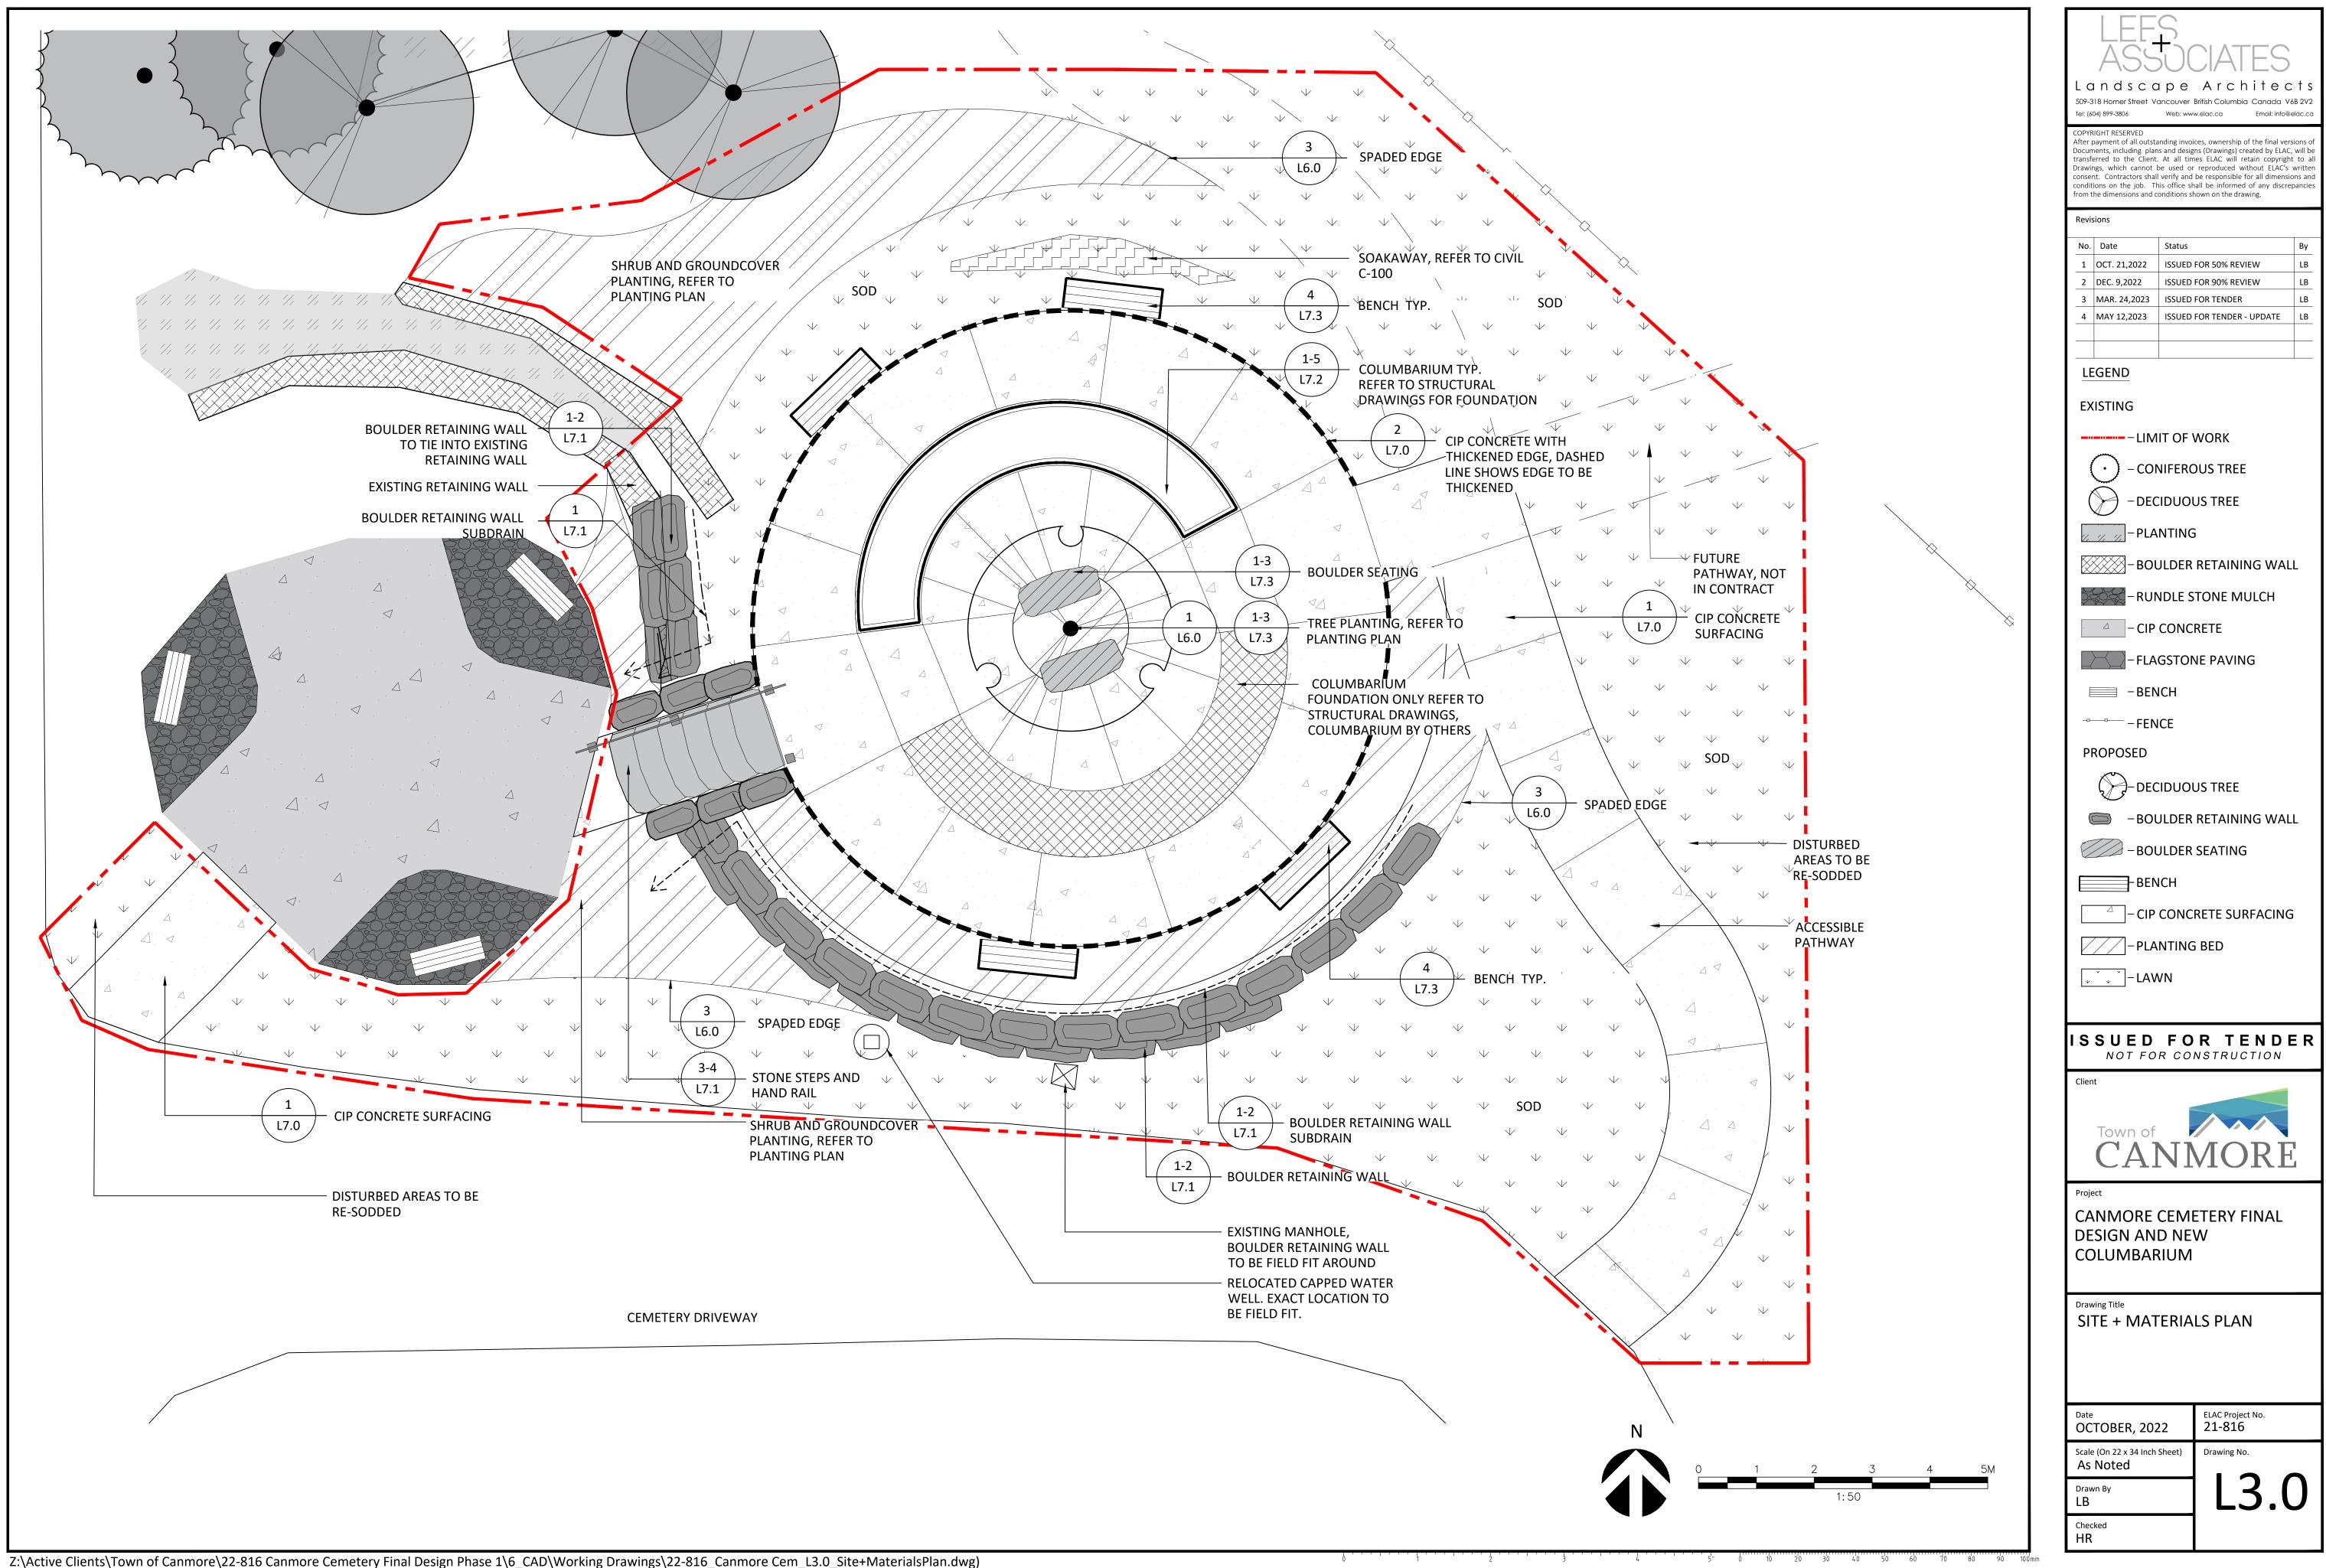

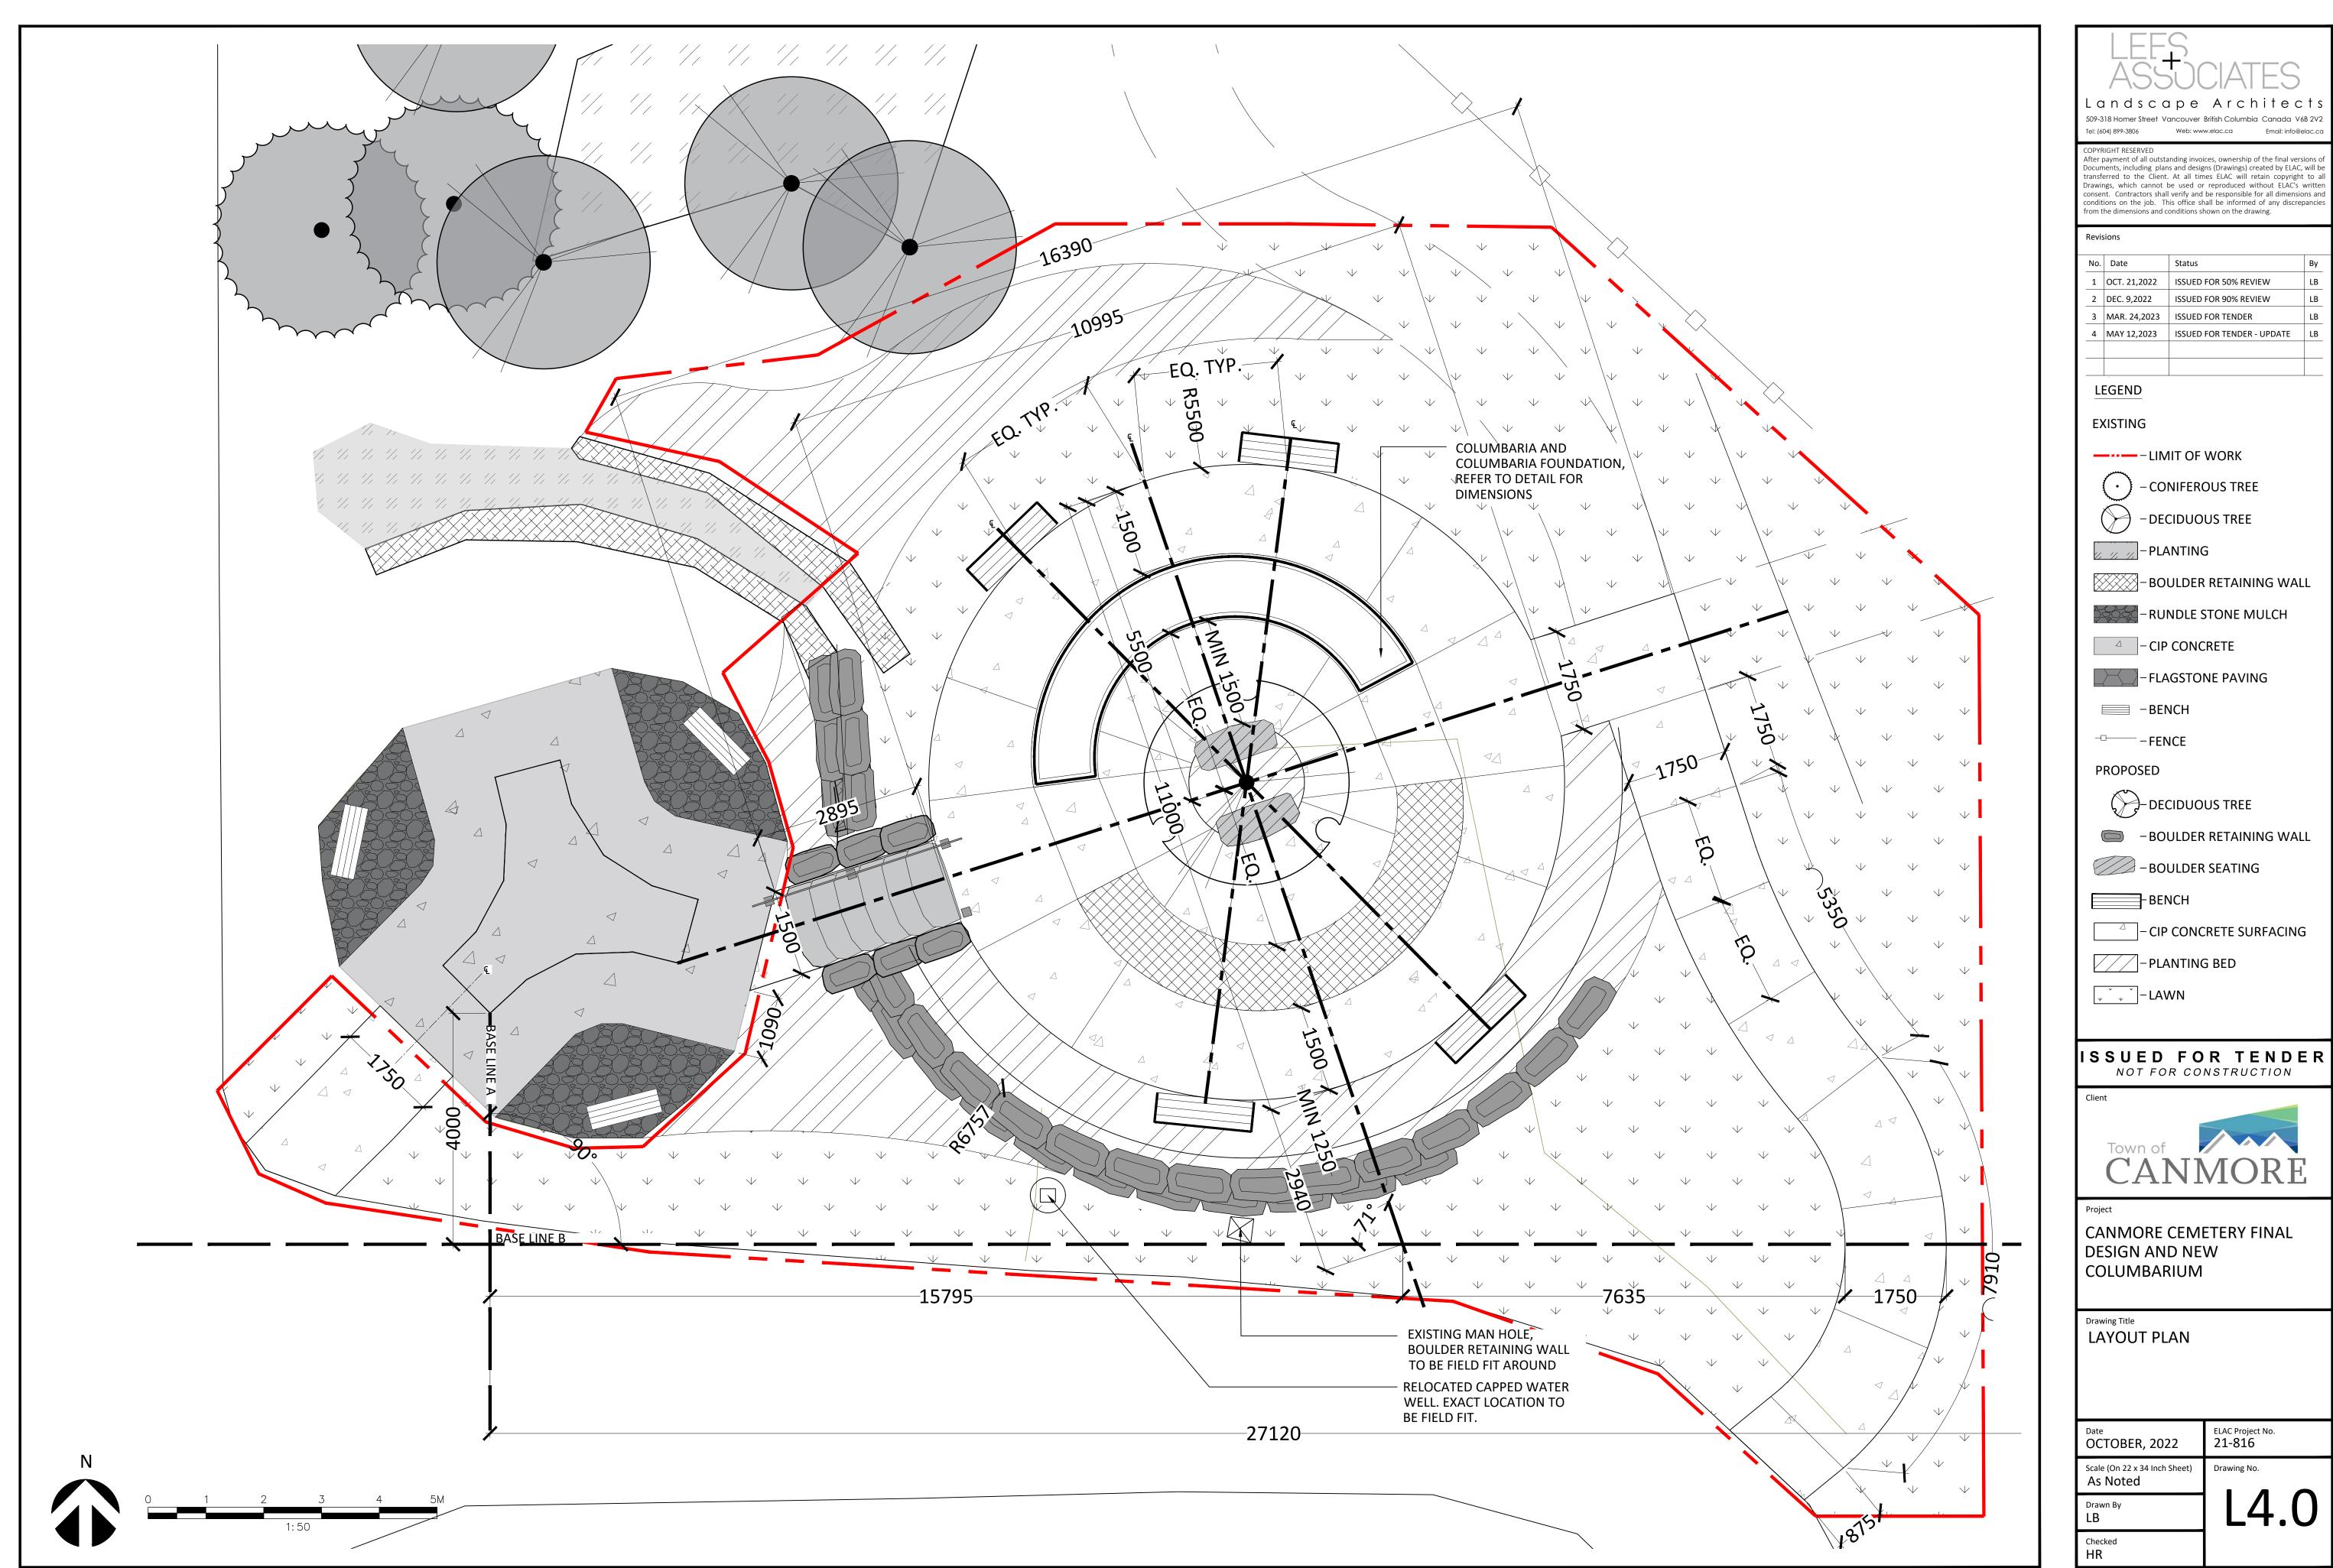andscape Architect 509-318 Homer Street Vancouver British Columbia Canada V6B 2V2 Web: www.elac.ca Email: info@elac.c Tel: (604) 899-3806
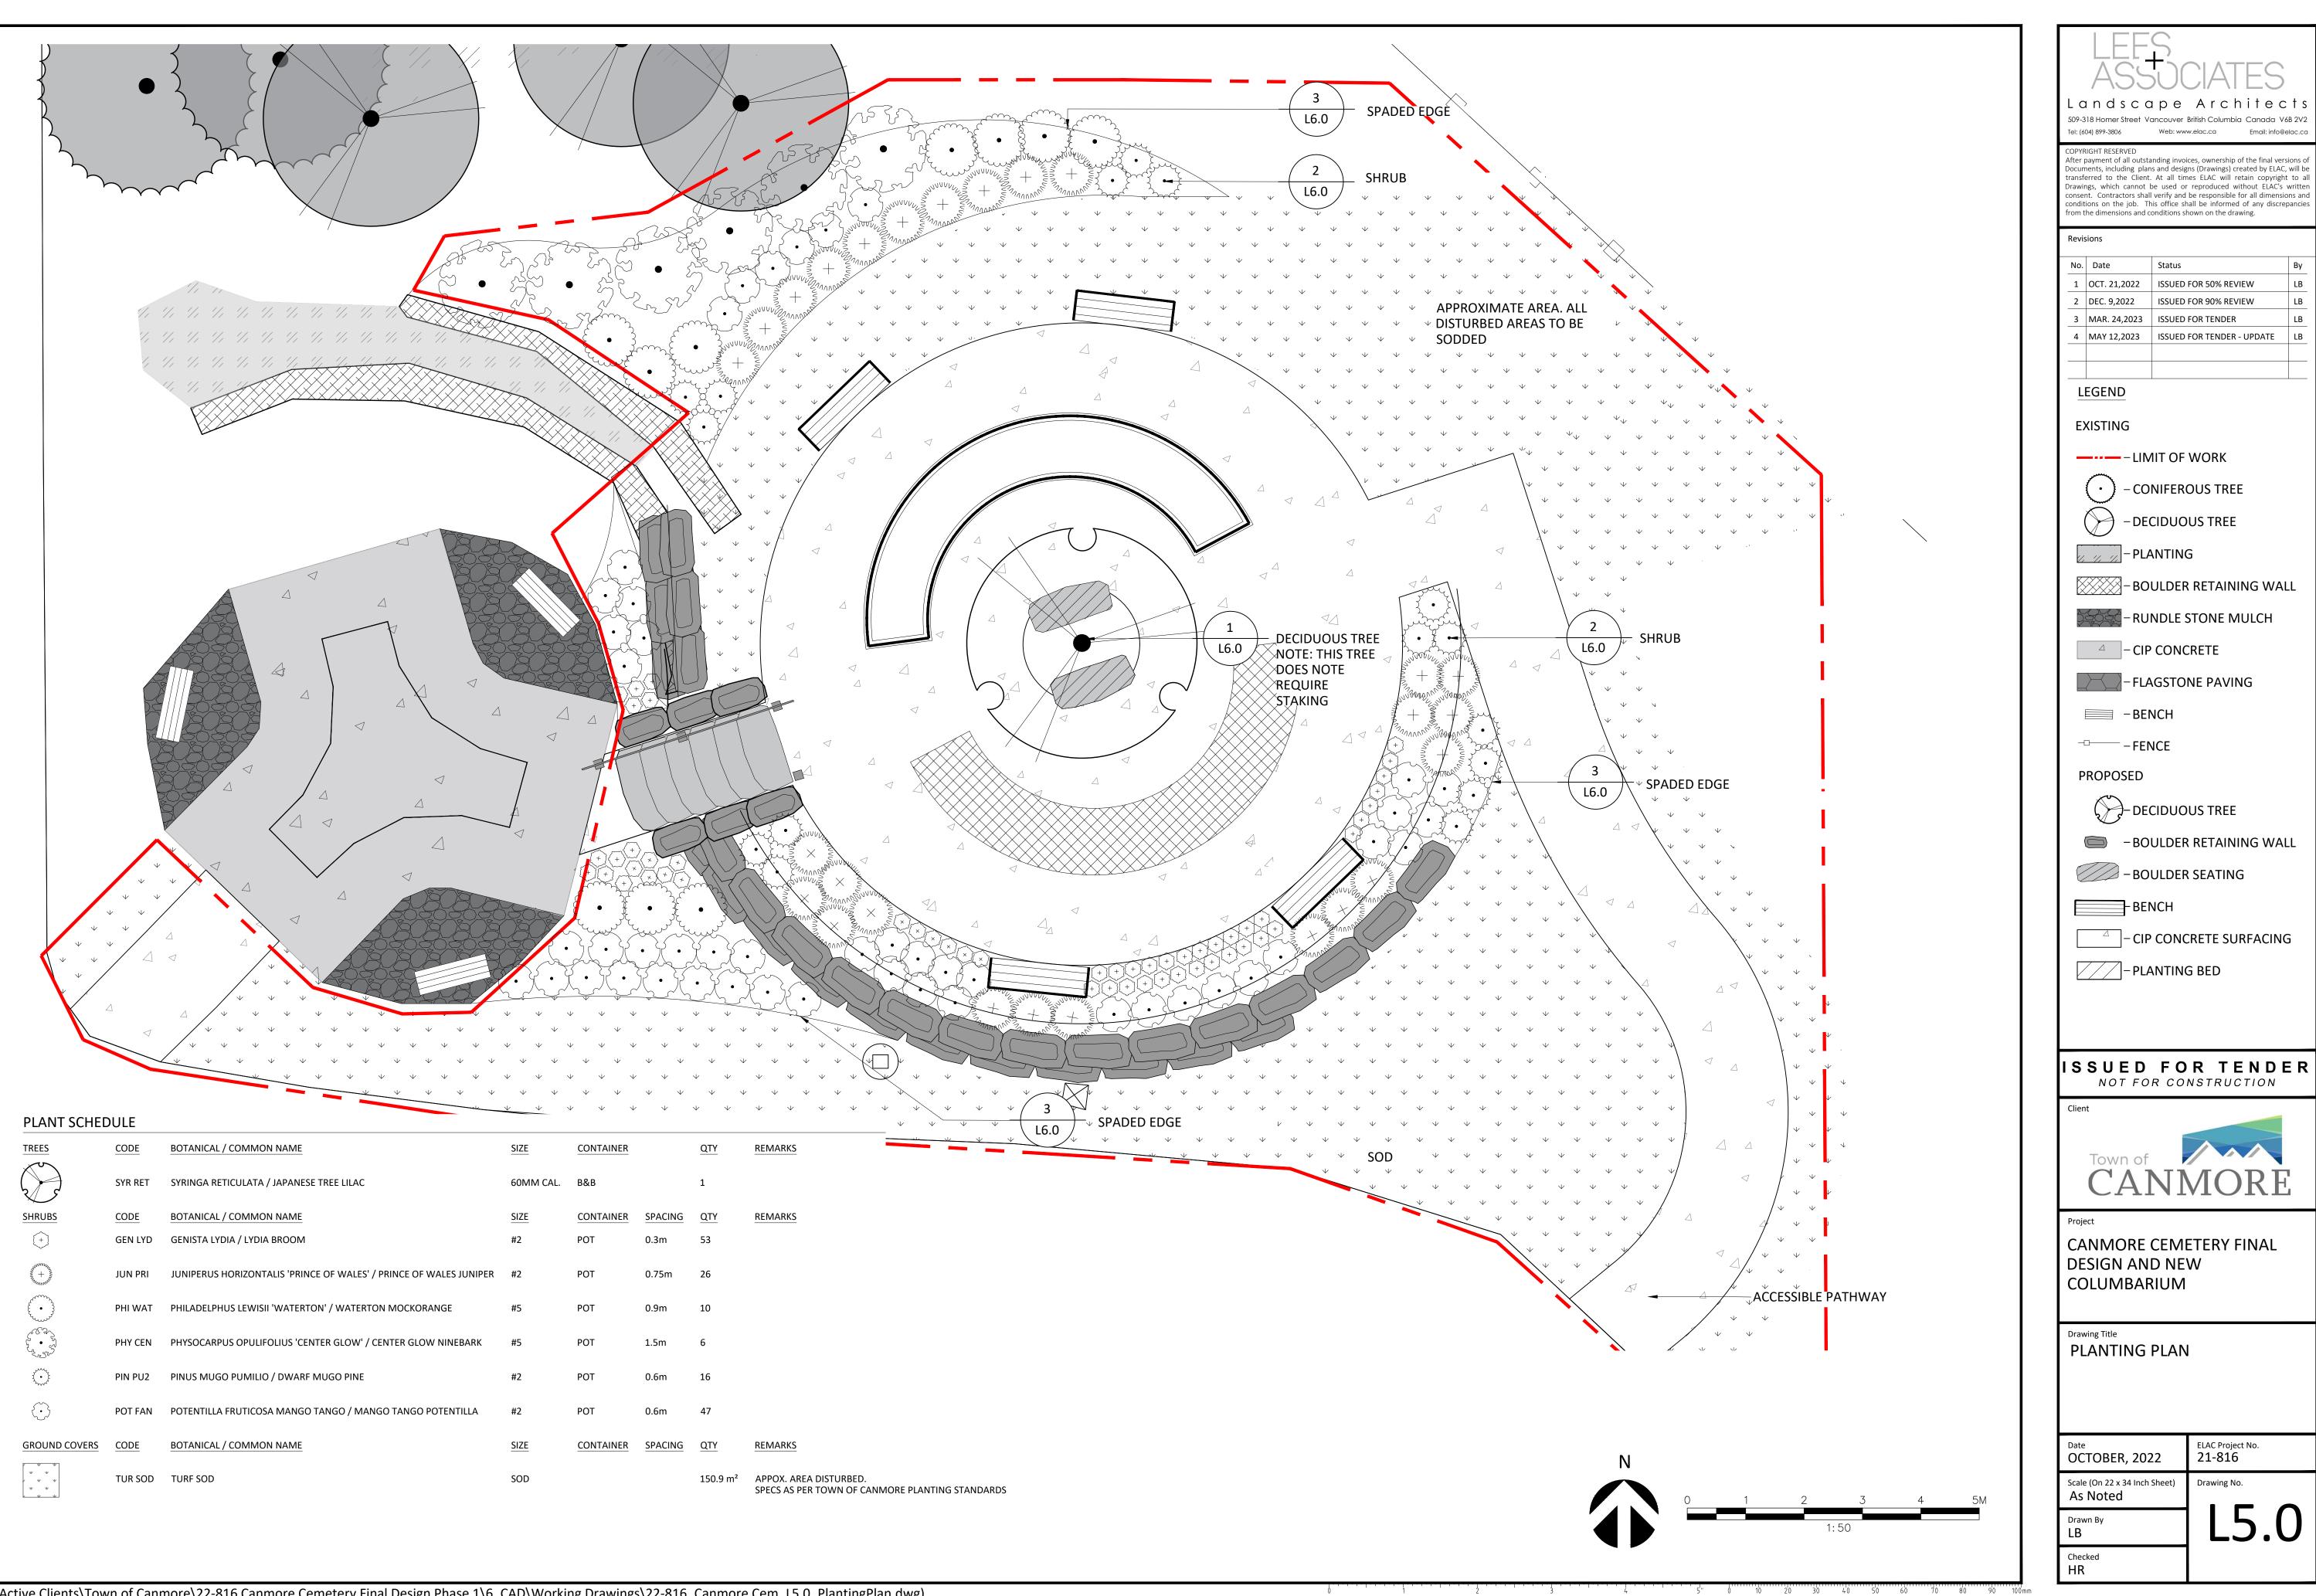
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Revisions

No. Date

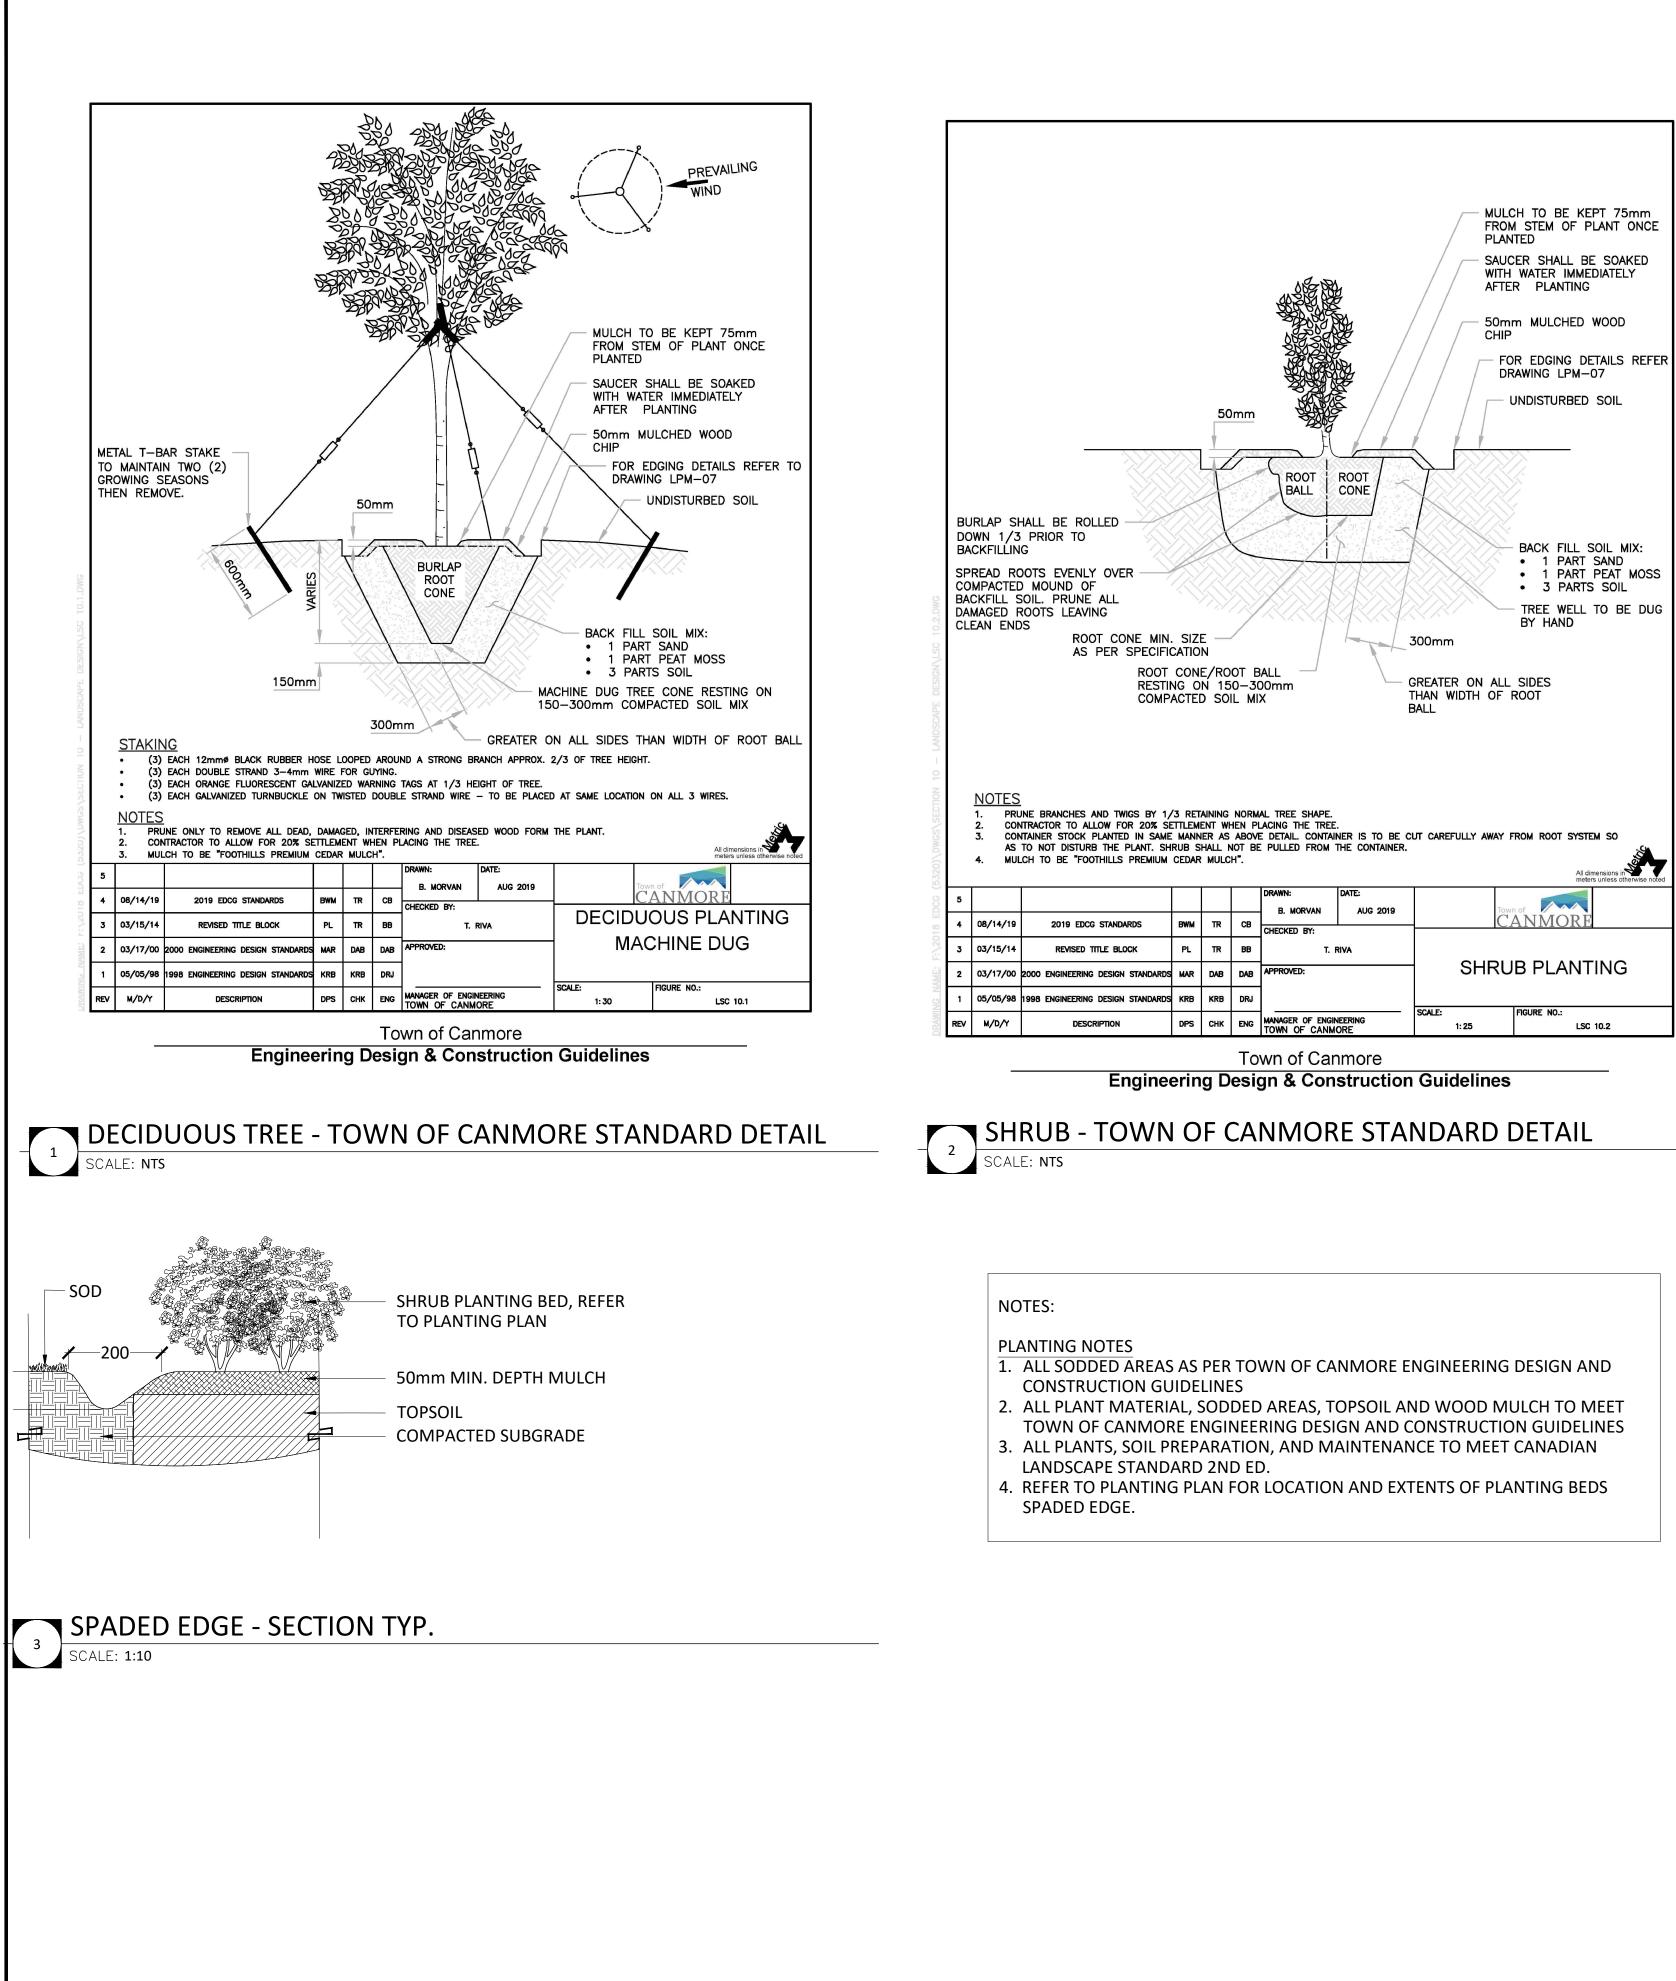2 DEC. 9,2022

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ISSUED FOR 90% REVIEW

IB

Status

1 OCT. 21,2022 ISSUED FOR 50% REVIEW

4 MAY 12,2023 ISSUED FOR TENDER - UPDATE

3 MAR. 24,2023 ISSUED FOR TENDER

PROVIDE AND MAINTAIN **PROTECTIVE FENCING AT** DRIPLINE OF TREE. FENCE TO **BE MAINTAINED FOR FULL**

DURATION OF CONTRACT.

WOOD FENCE POSTS (1800 x 76 mm), NO LESS THAN EVERY 1500 mm APART.

SNOW FENCE (ORANGE POLY LAMINAR SAFETY NETTING OR APPROVED EQUIVALENT) SECURED BY WOOD POSTS. CROSS-BRACING IS REQUIRED.

NOTES

1. NO MATERIALS STOCKPILING PERMITTED W/ IN ZONE A/B/C.


2. OPERATION OF HEAVY EQUIPMENT TO BE KEPT TO STRICT MINIMUM W/ IN ZONE A/B/C. ACCESS SUBJECT TO APPROVAL BY PROJECT REPRESENTATIVE.

3 PROTECTIVE FENCING LOCATION MAY BE TEMPORARILY ADJUSTED TO ACCOMMODATE NEW **CONSTRUCTION - SUBJECT TO** APPROVAL BY PROJECT REPRESENTATIVE.

4. UTILIZE HAND METHODS TO MINIMIZE ROOT DAMAGE. CLEANLY SEVER EXPOSED ROOTS PER ACCEPTED INDUSTRIAL STANDARDS TO BEST HORTICULTURAL PRACTICE.

5'' Ô 1Ô 2Ô 3Ô 4Ô 5Ô 6Ô 7Ô 8Ô 9Ô 10Ômm

ISSUED FOR TENDER NOT FOR CONSTRUCTION				
Client Town of CANN	MORE			
Project CANMORE CEMETERY FINAL DESIGN AND NEW COLUMBARIUM				
Drawing Title DETAILS PLANTING				
Date OCTOBER, 2022	ELAC Project No. 21-816			
Scale (On 22 x 34 Inch Sheet) As Noted	Drawing No.			
Drawn By LB Checked	L6.0			

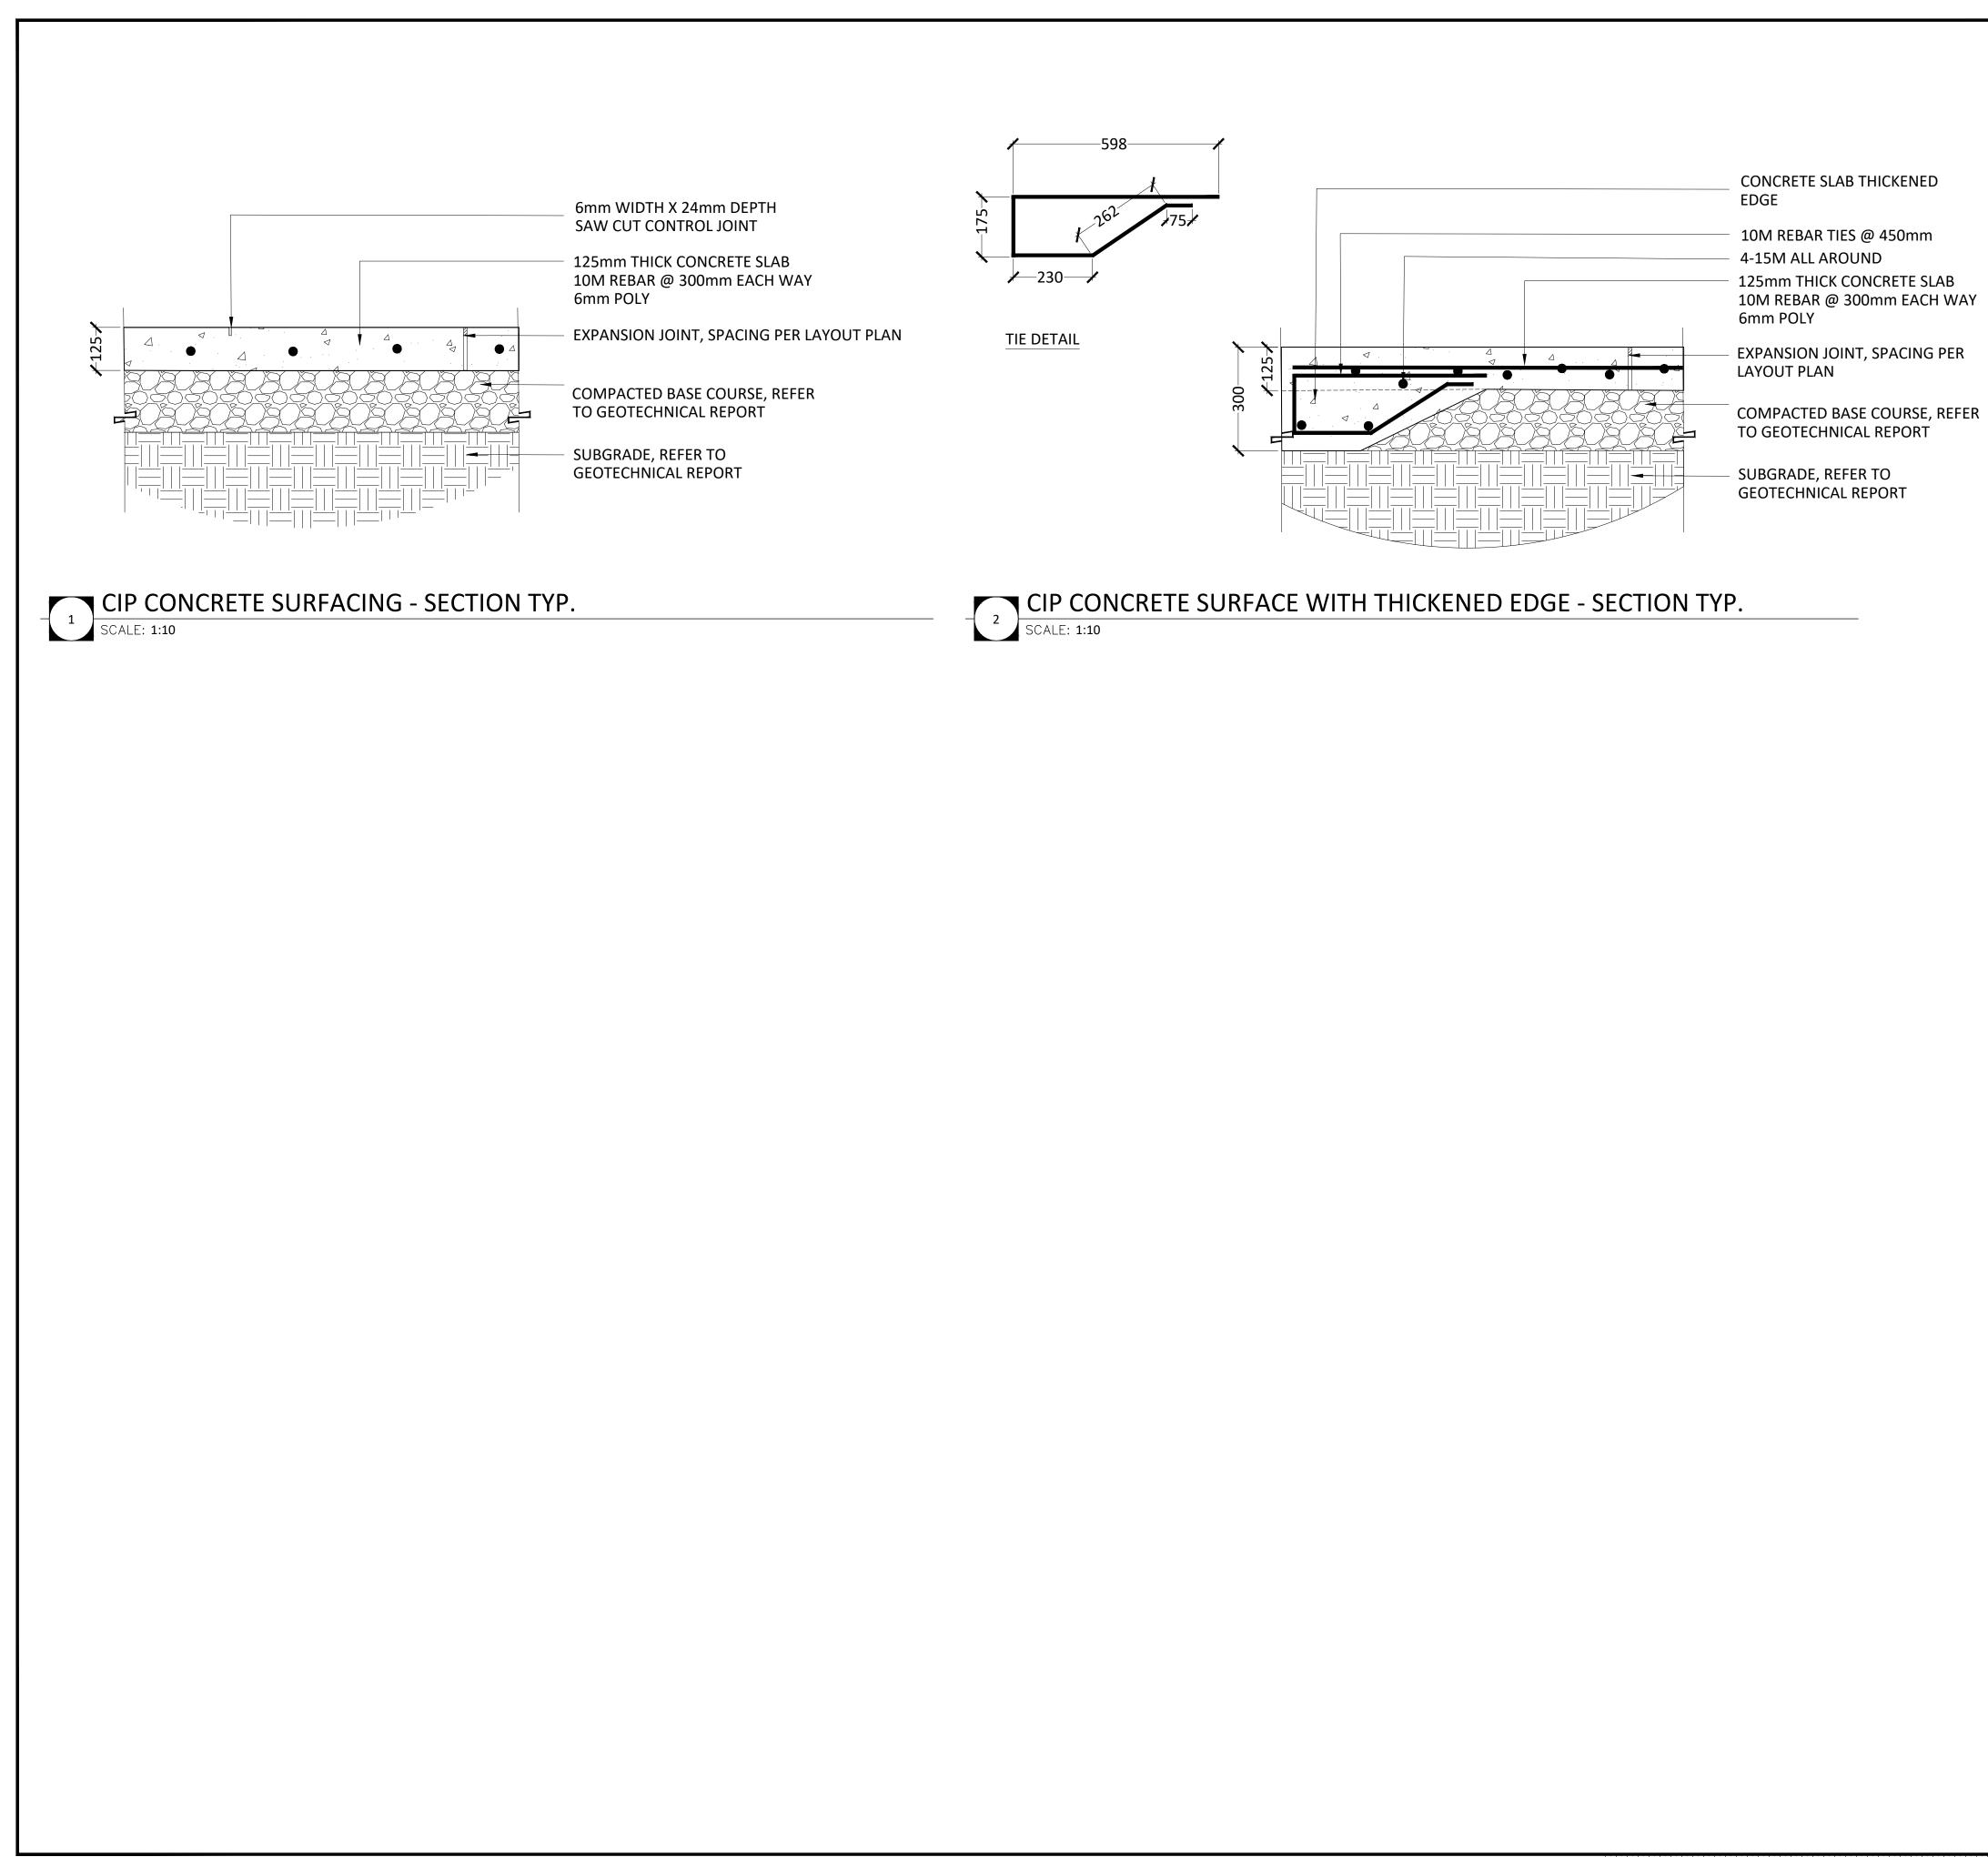

NOTES

CIP CONCRETE SURFACING

- 1. MEDIUM BROOM FINISH
- NO TROWEL EDGE
 GRADING, REFER TO CIVIL

DRAWINGS



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ISSUED FOR TENDER NOT FOR CONSTRUCTION



Project

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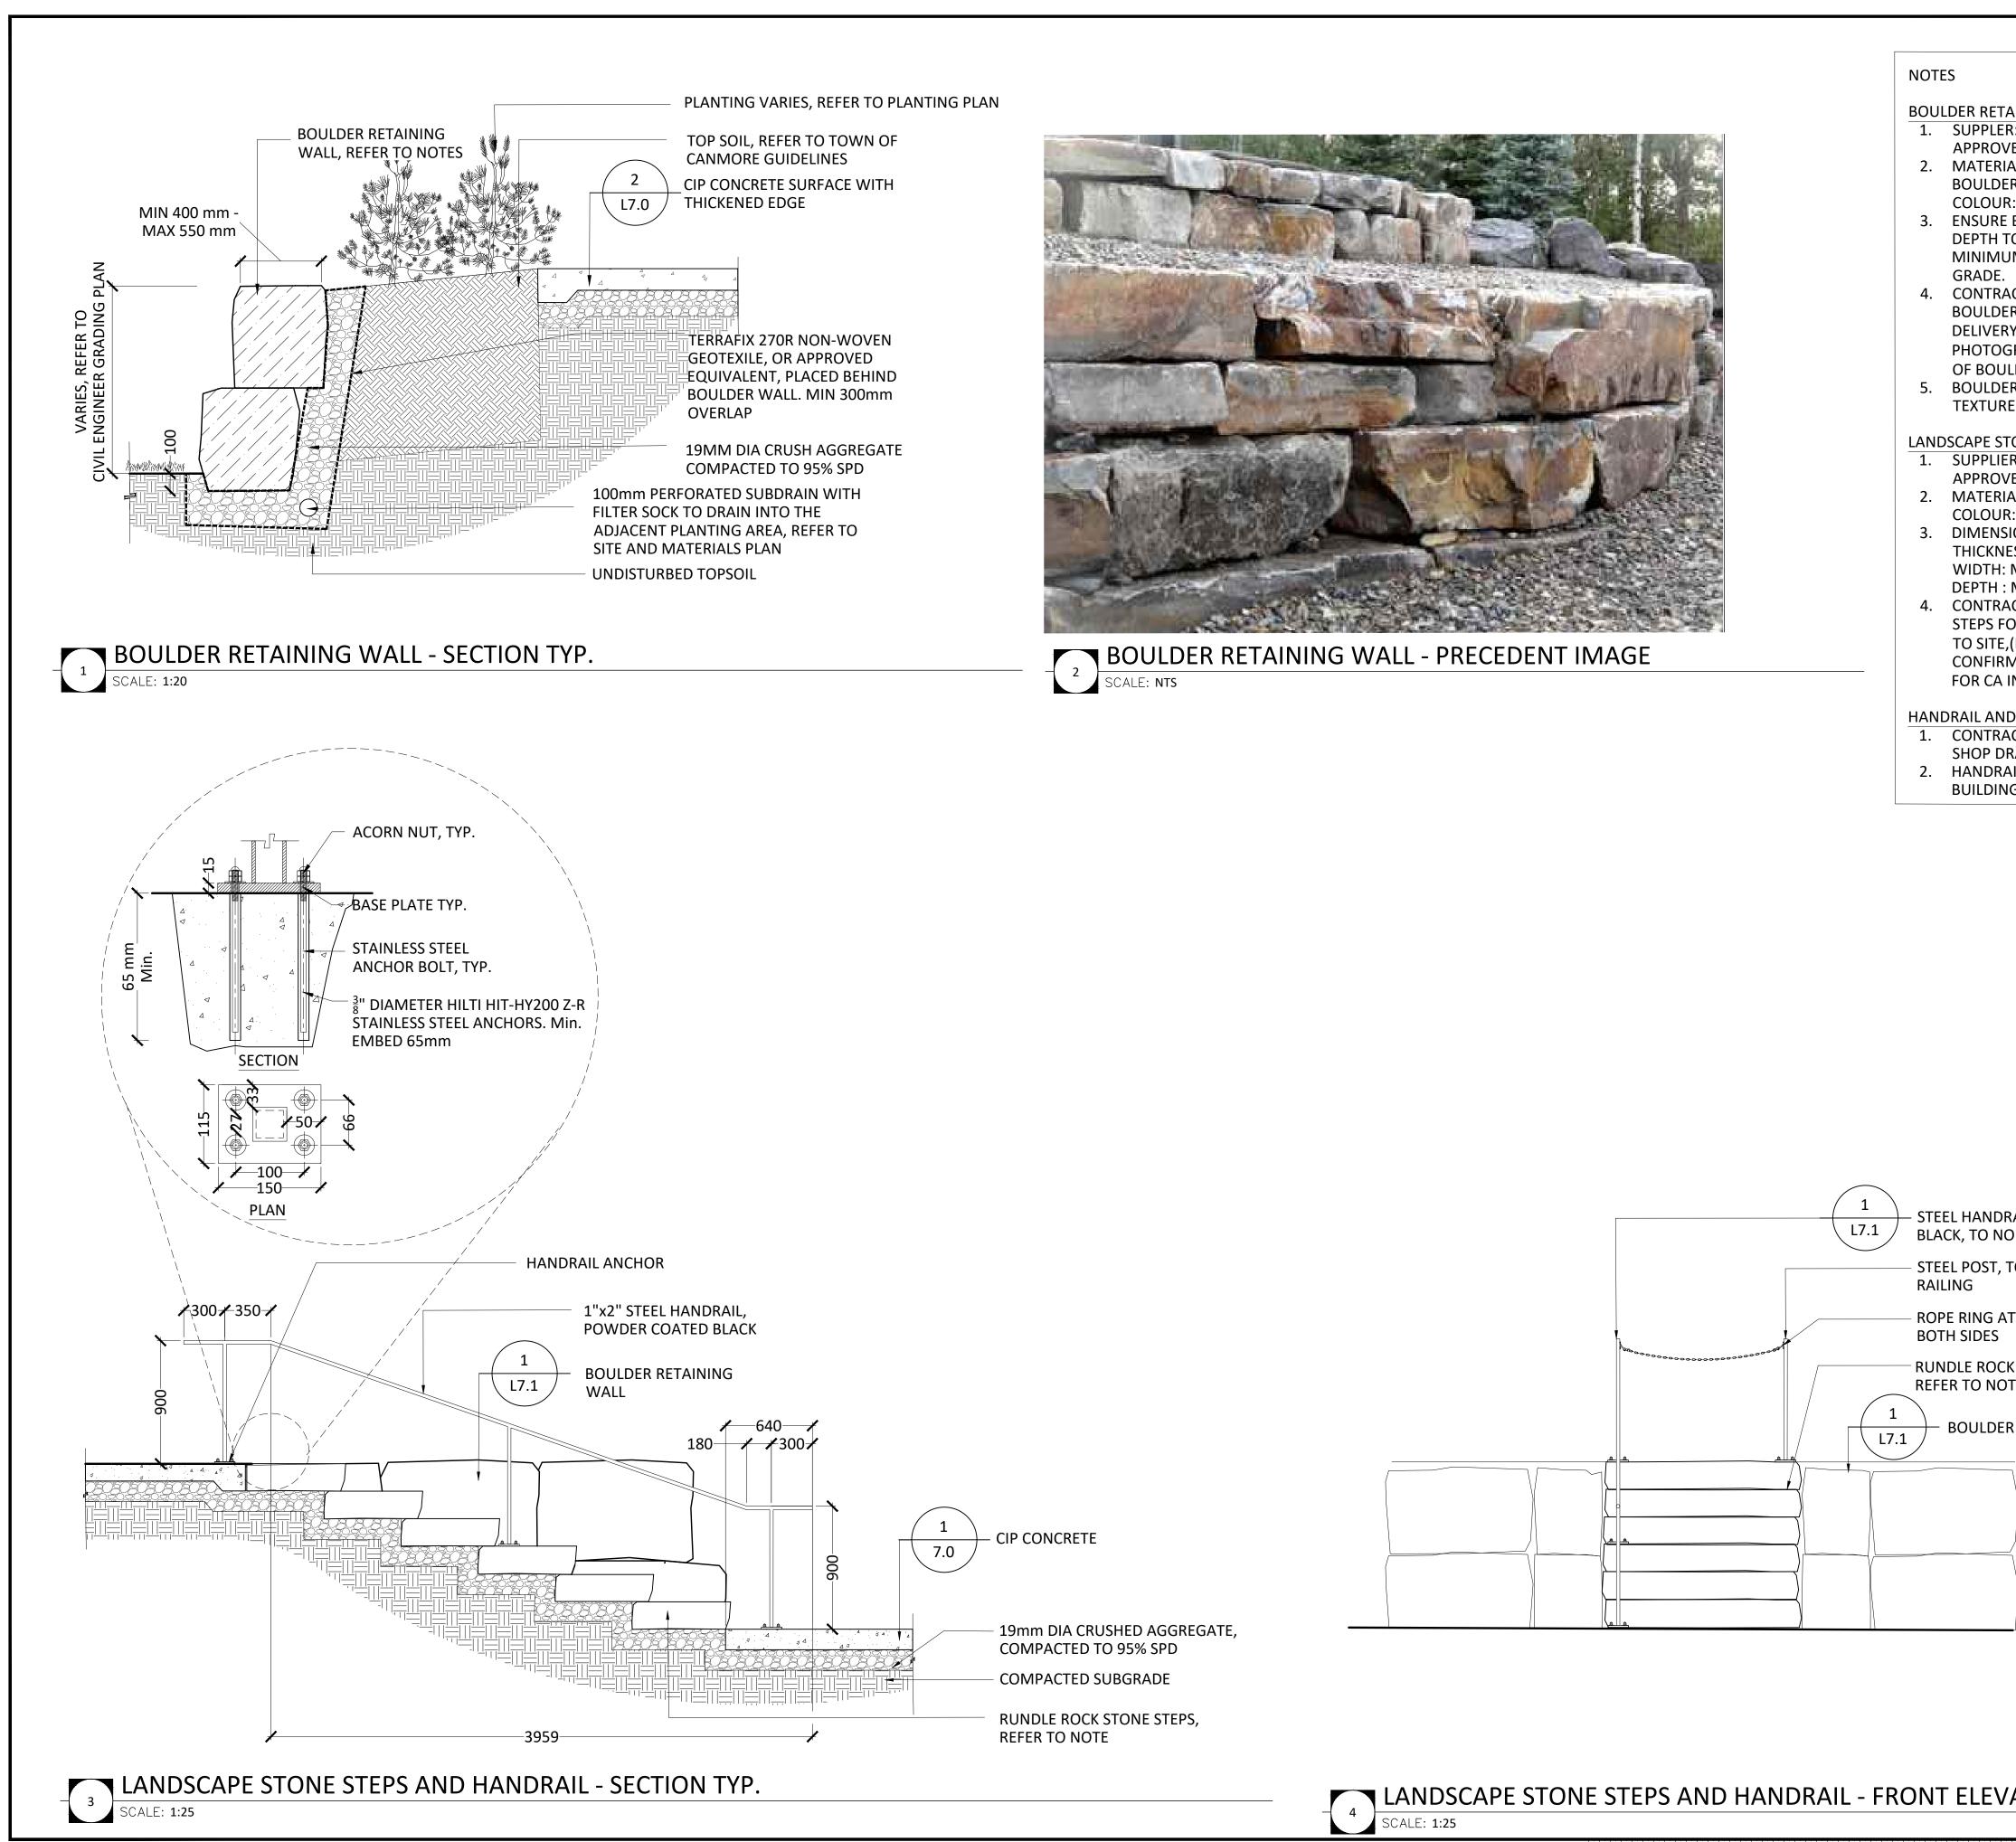
5'' 0 10 20 30 4'0 50 60 70 80 90 100mm

Client

CANMORE CEMETERY FINAL DESIGN AND NEW COLUMBARIUM

Drawing Title DETAILS SURFACES

Date OCTOBER, 2022	ELAC Project No. 21-816
Scale (On 22 x 34 Inch Sheet) As Noted	Drawing No.
Drawn By LB	L7.0
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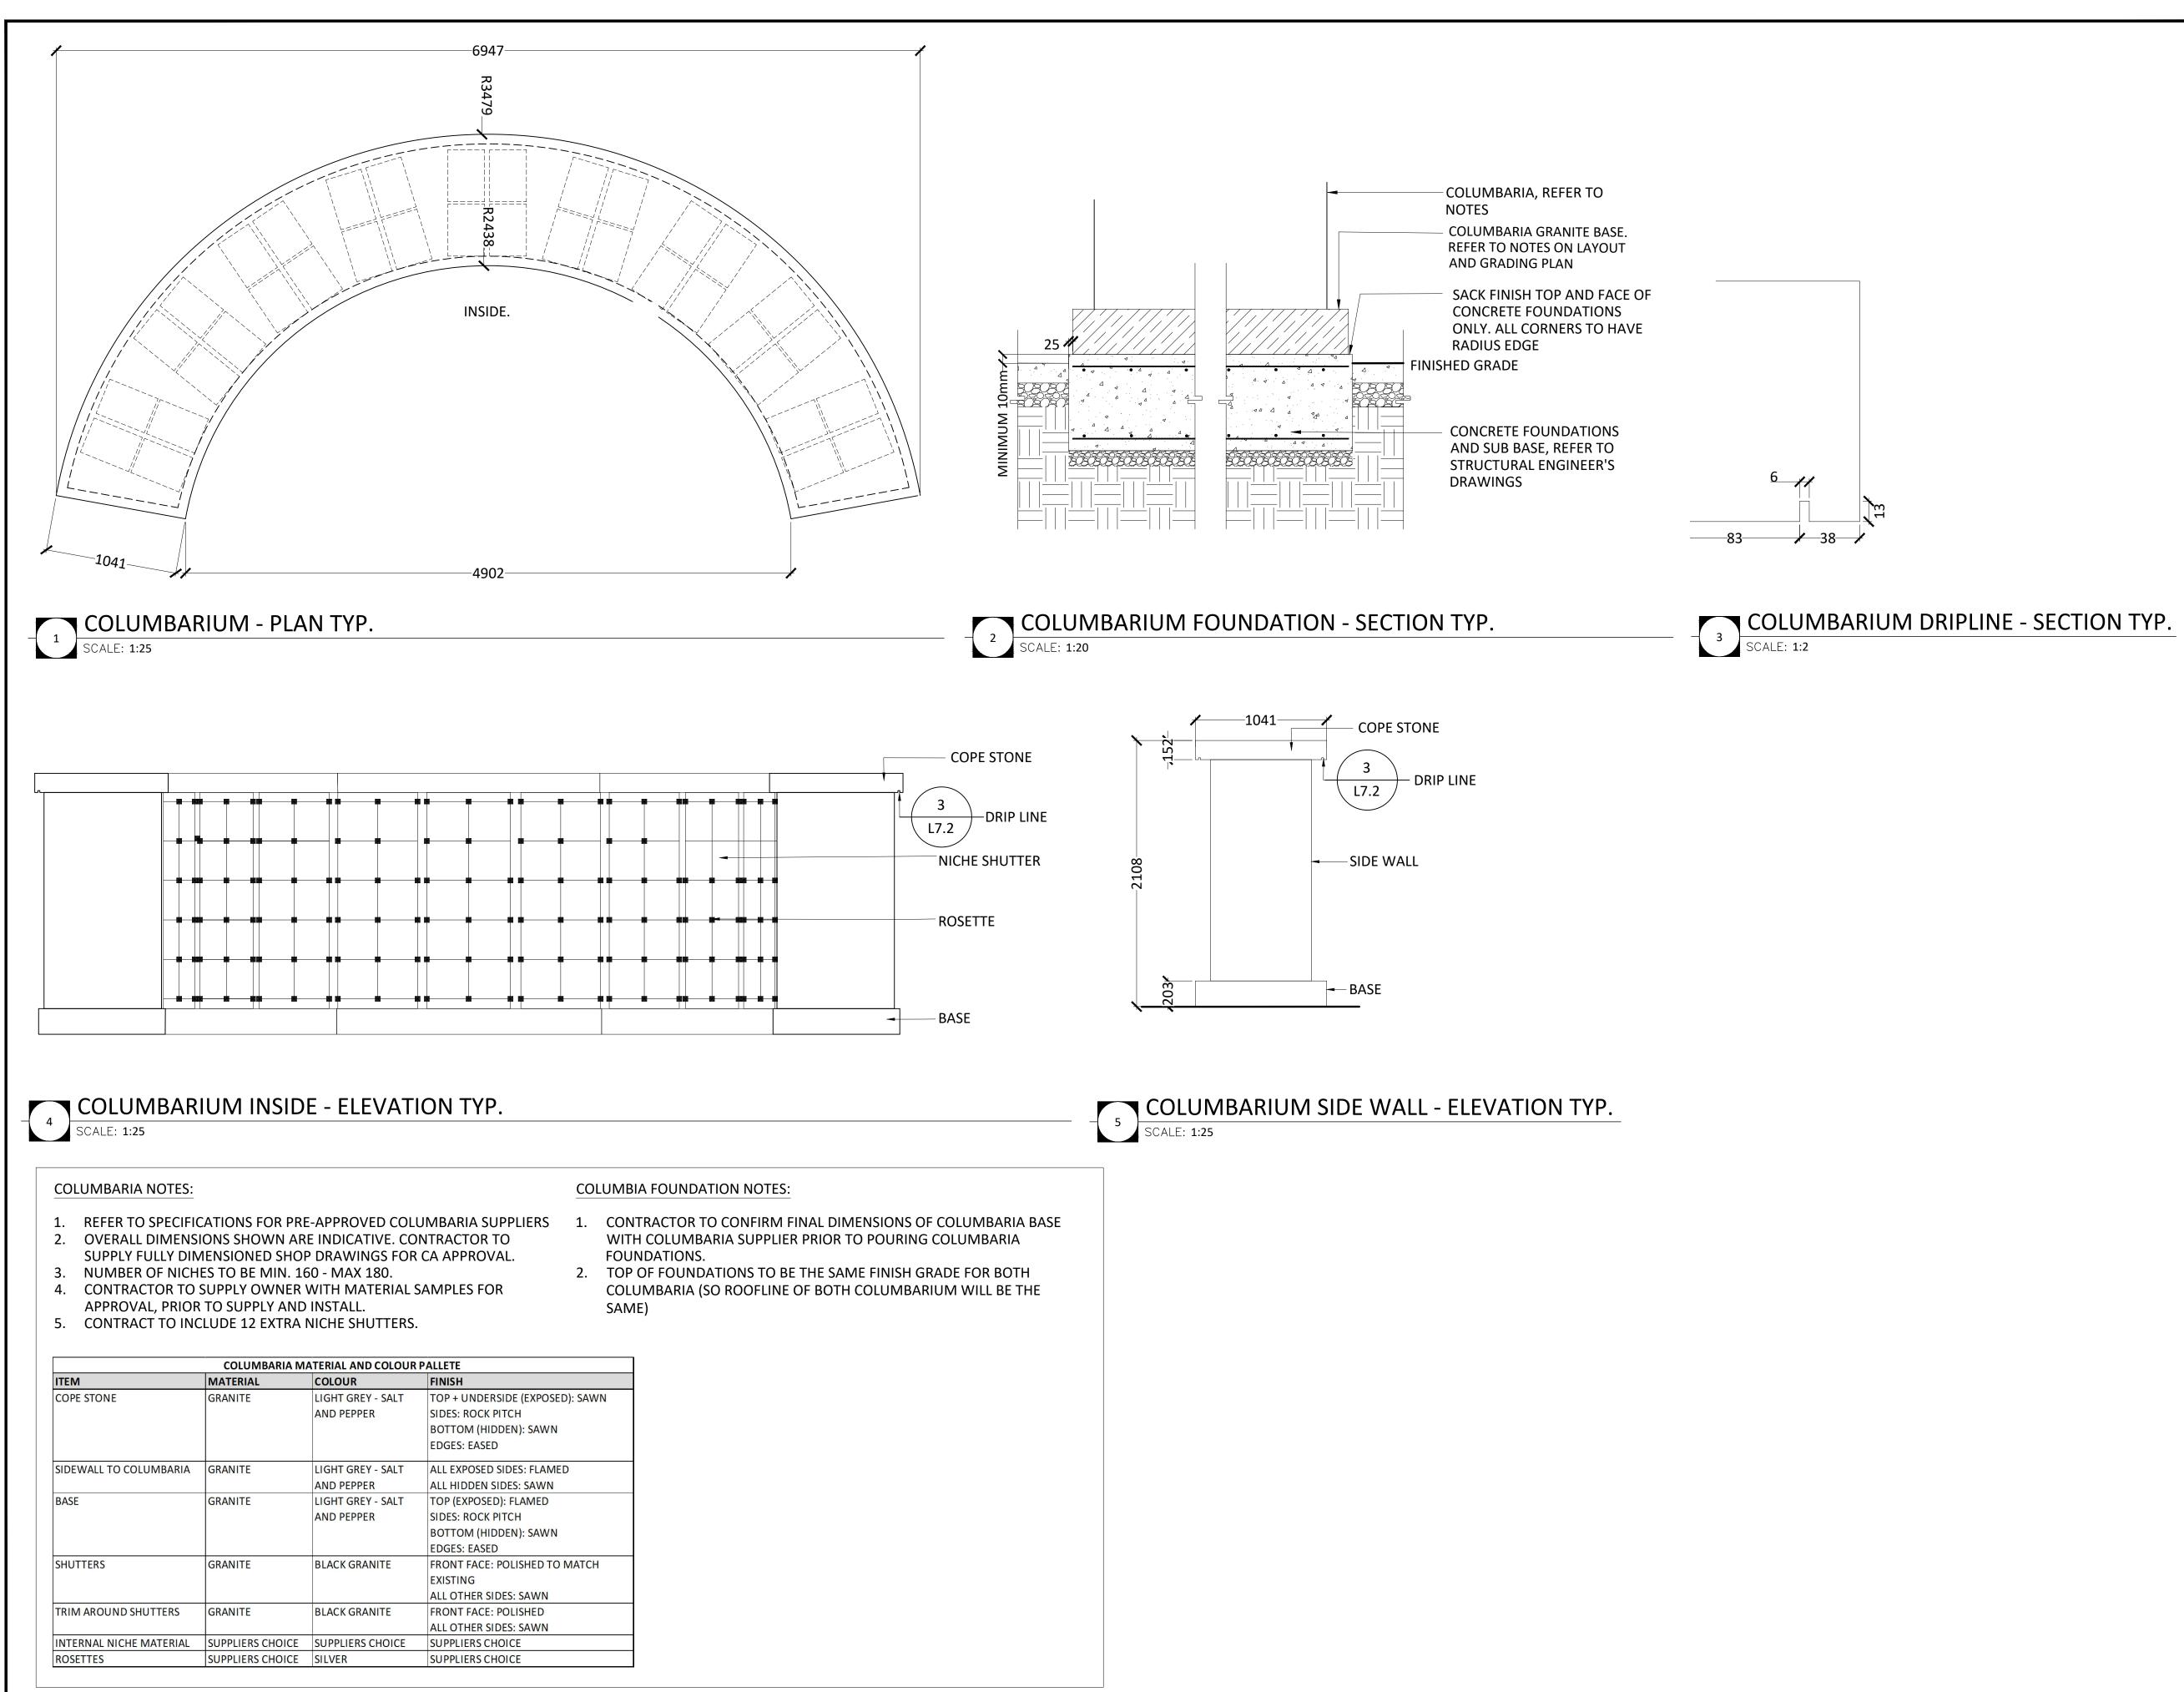
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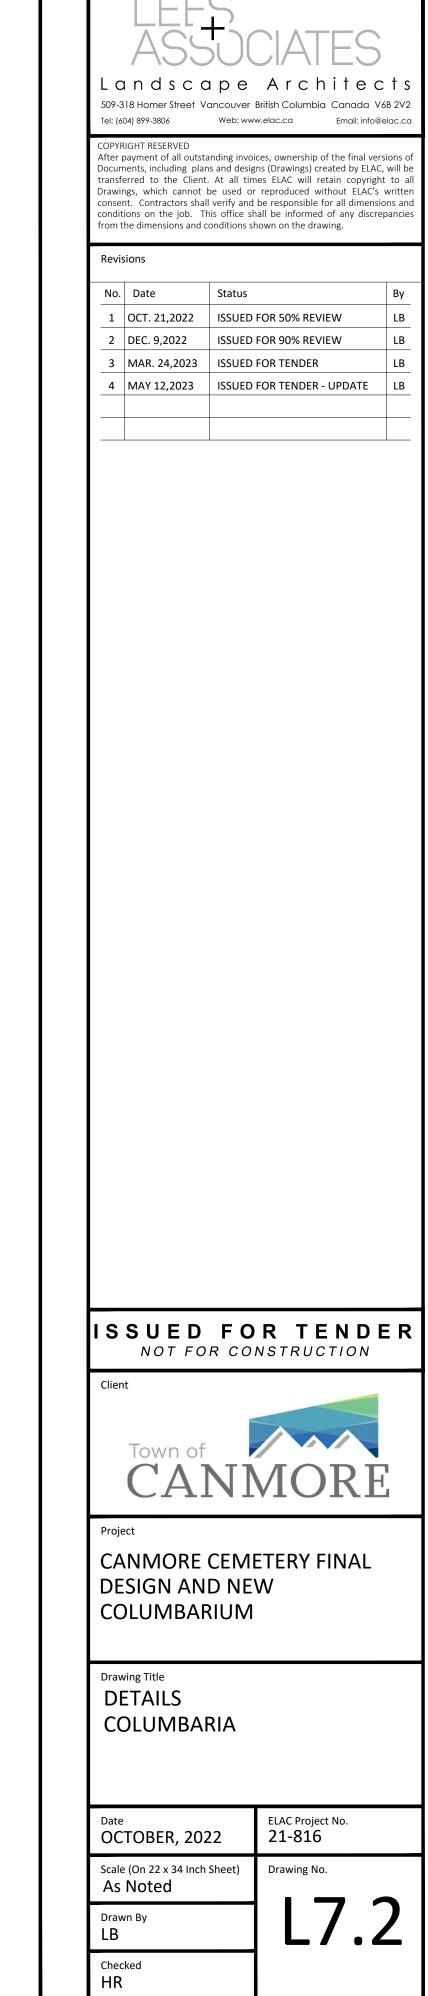


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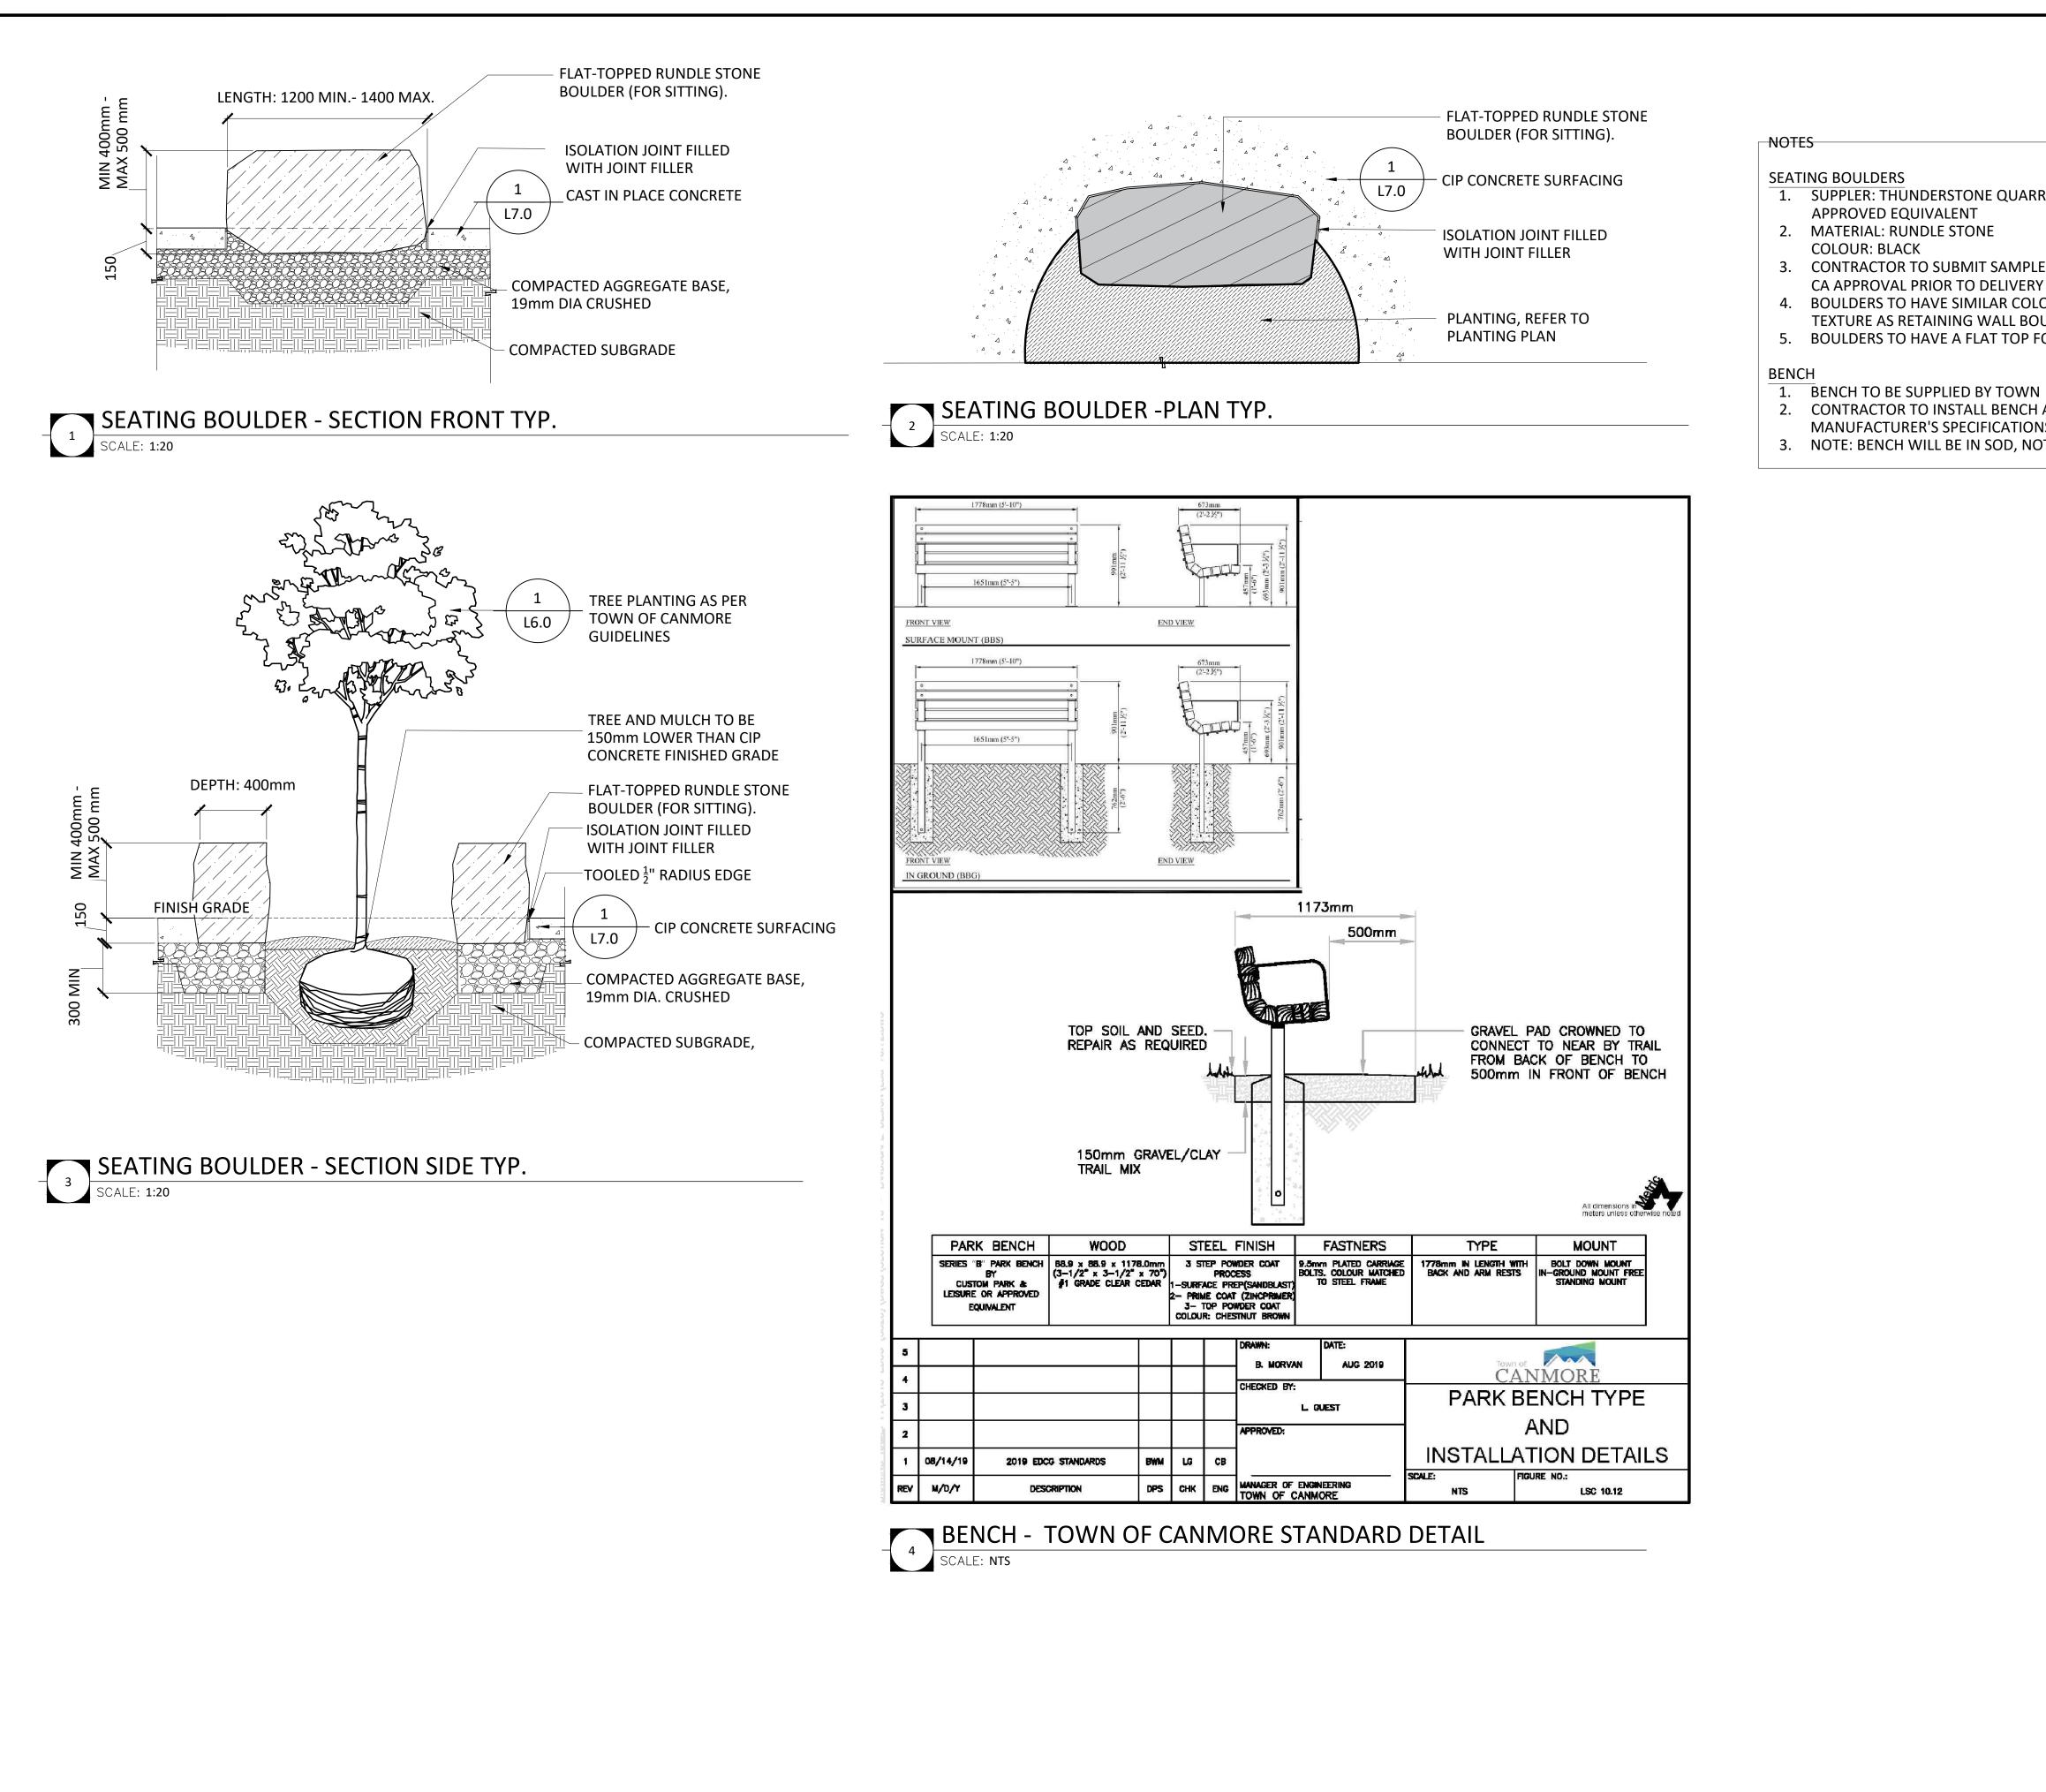
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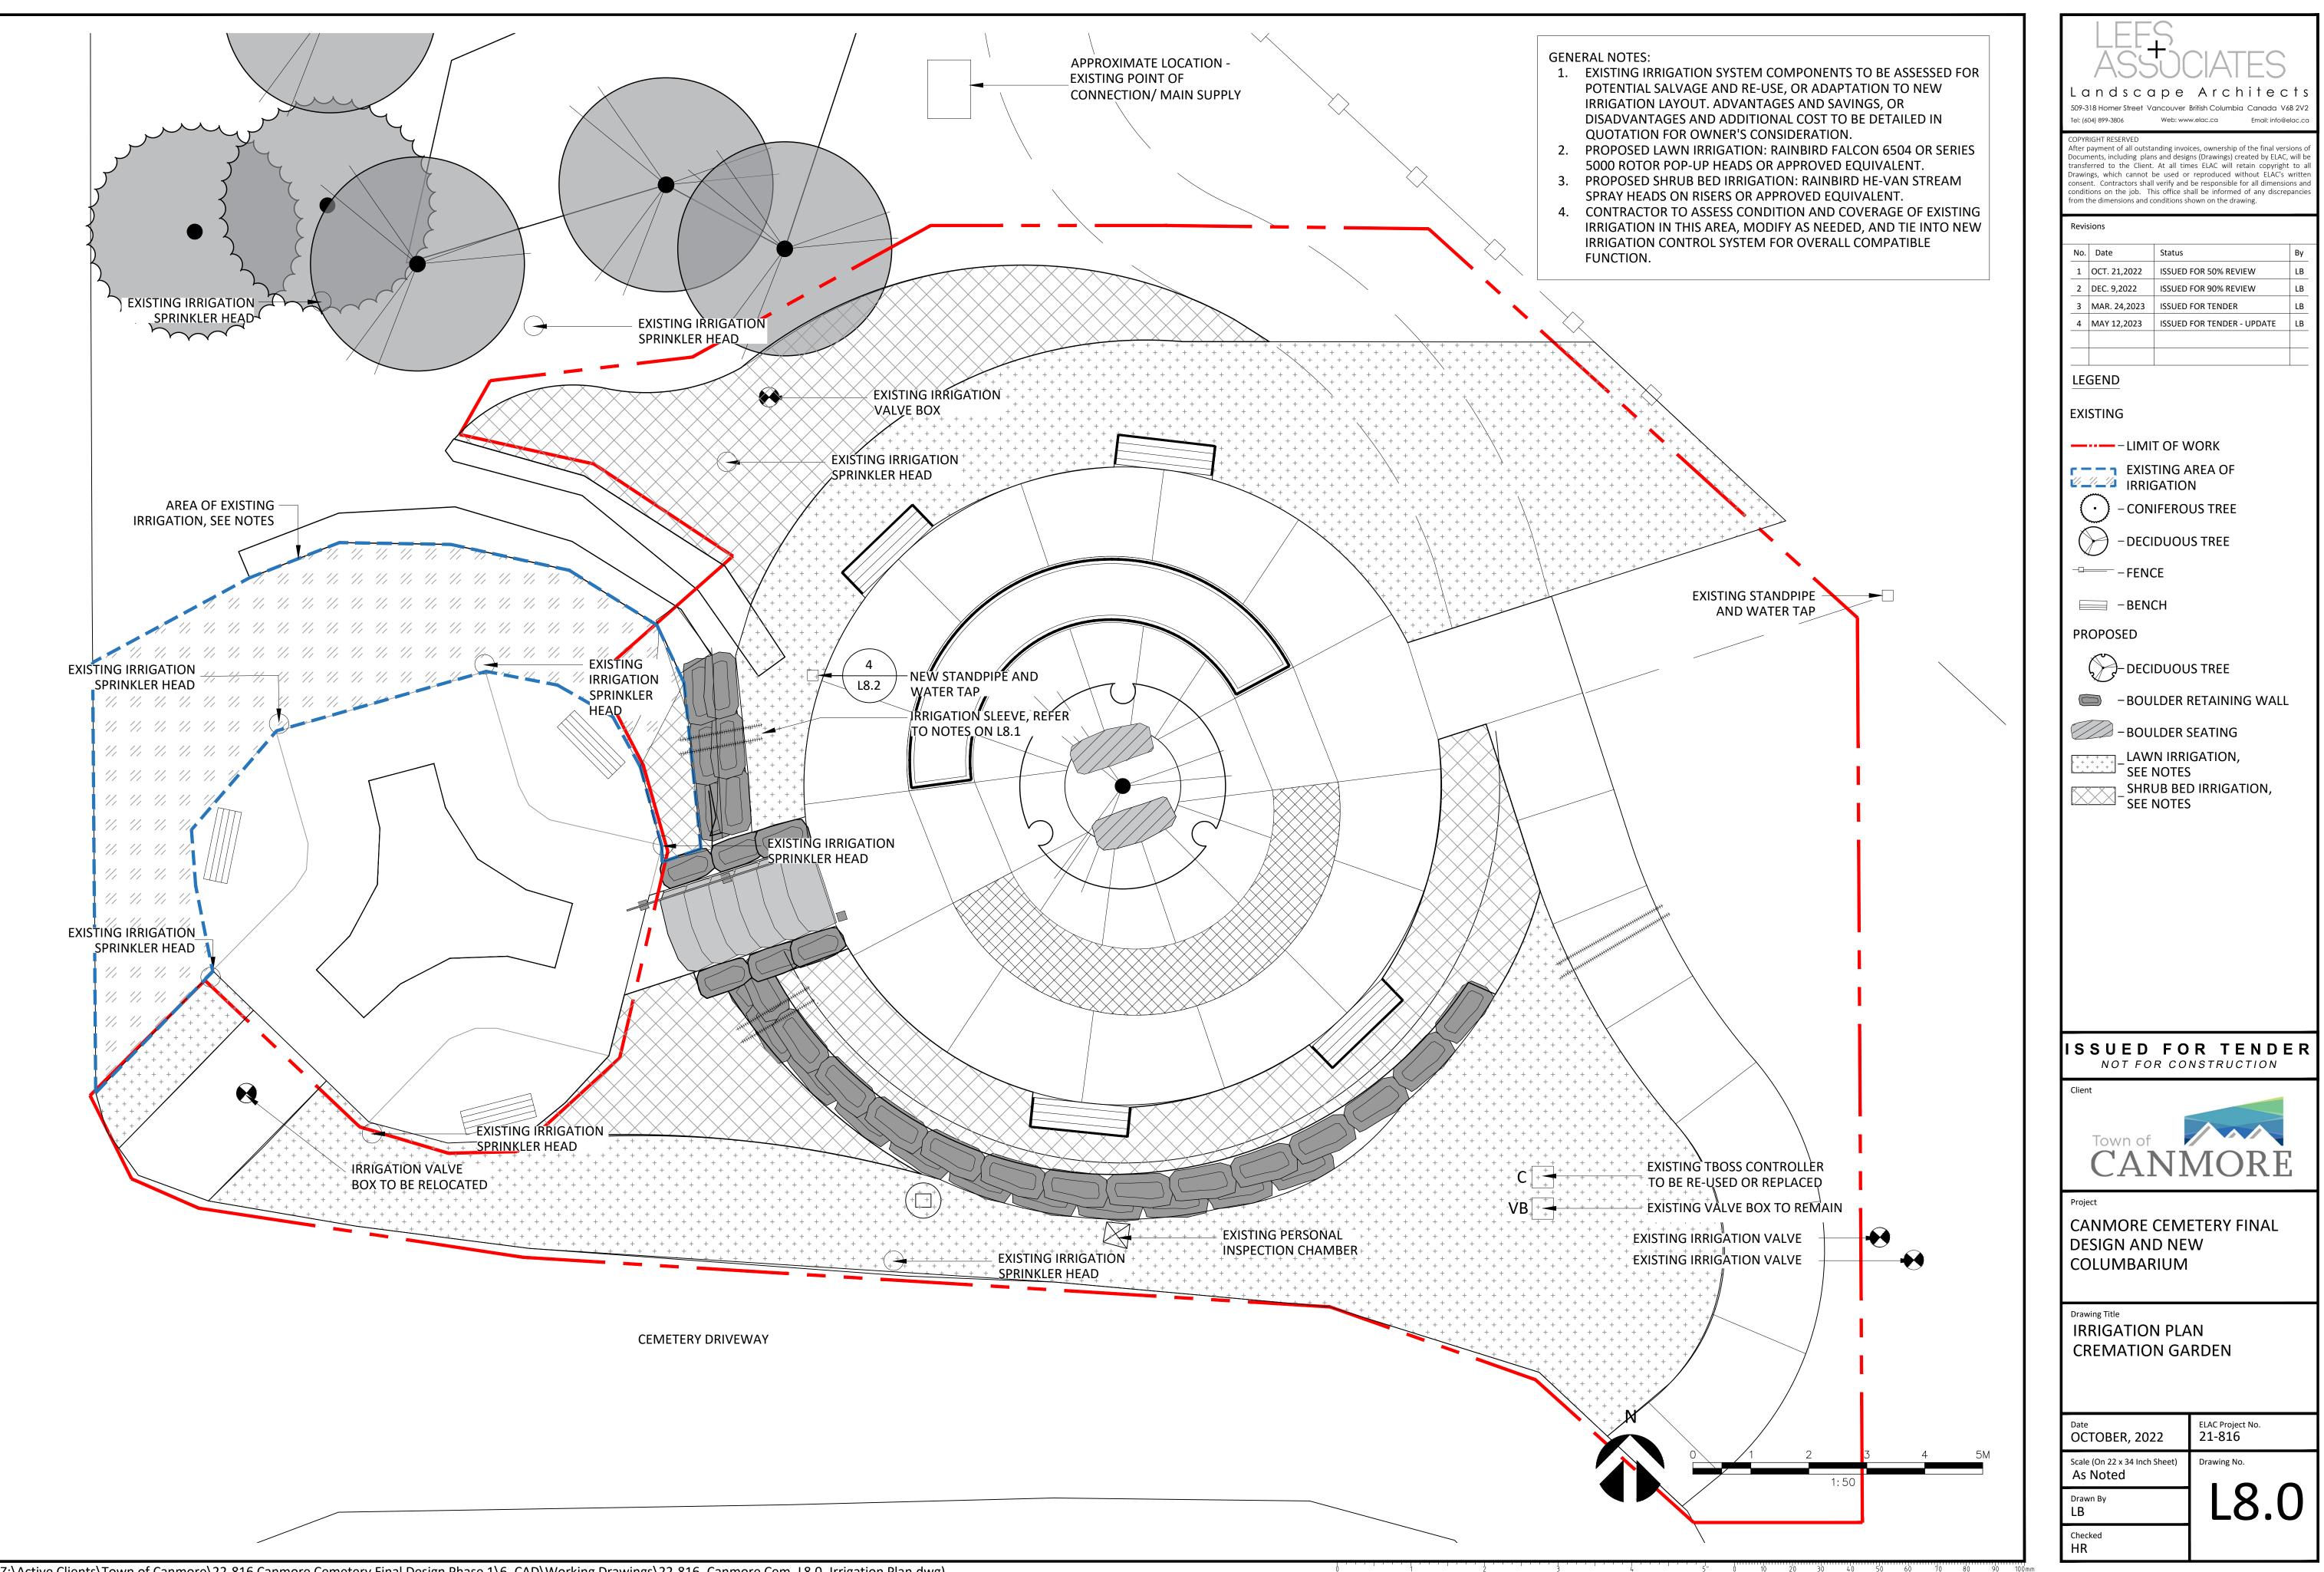




5" Ó 10 20 30 40 50 60 70 80 90 100mm




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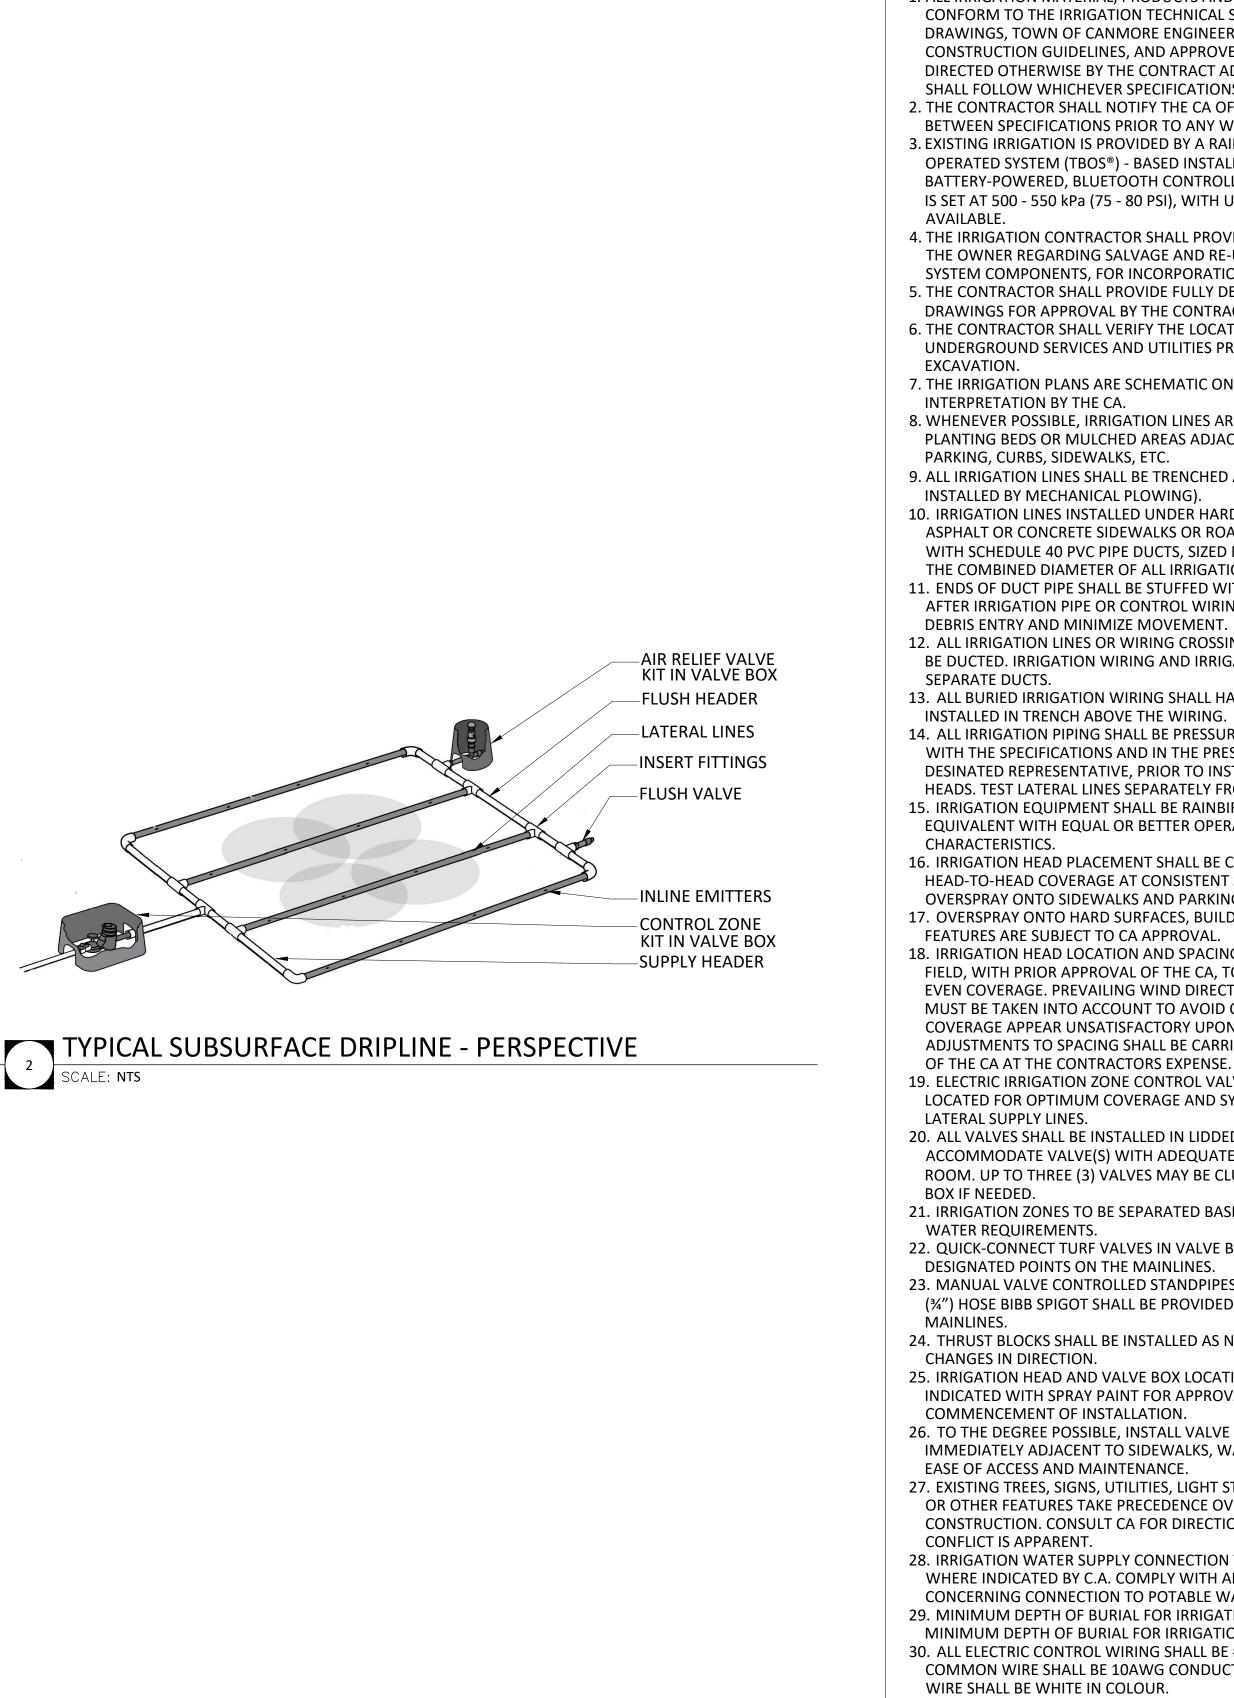


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^{5&#}x27;' Ô 1Ô 2Ô 3Ô 4Ô 5Ô 6Ô 7Ô 8Ô 9Ô 10Ômm



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- VALVES.
- VALVE BOX IN EACH RUN.
- OPERATION THAT MAY ARISE.

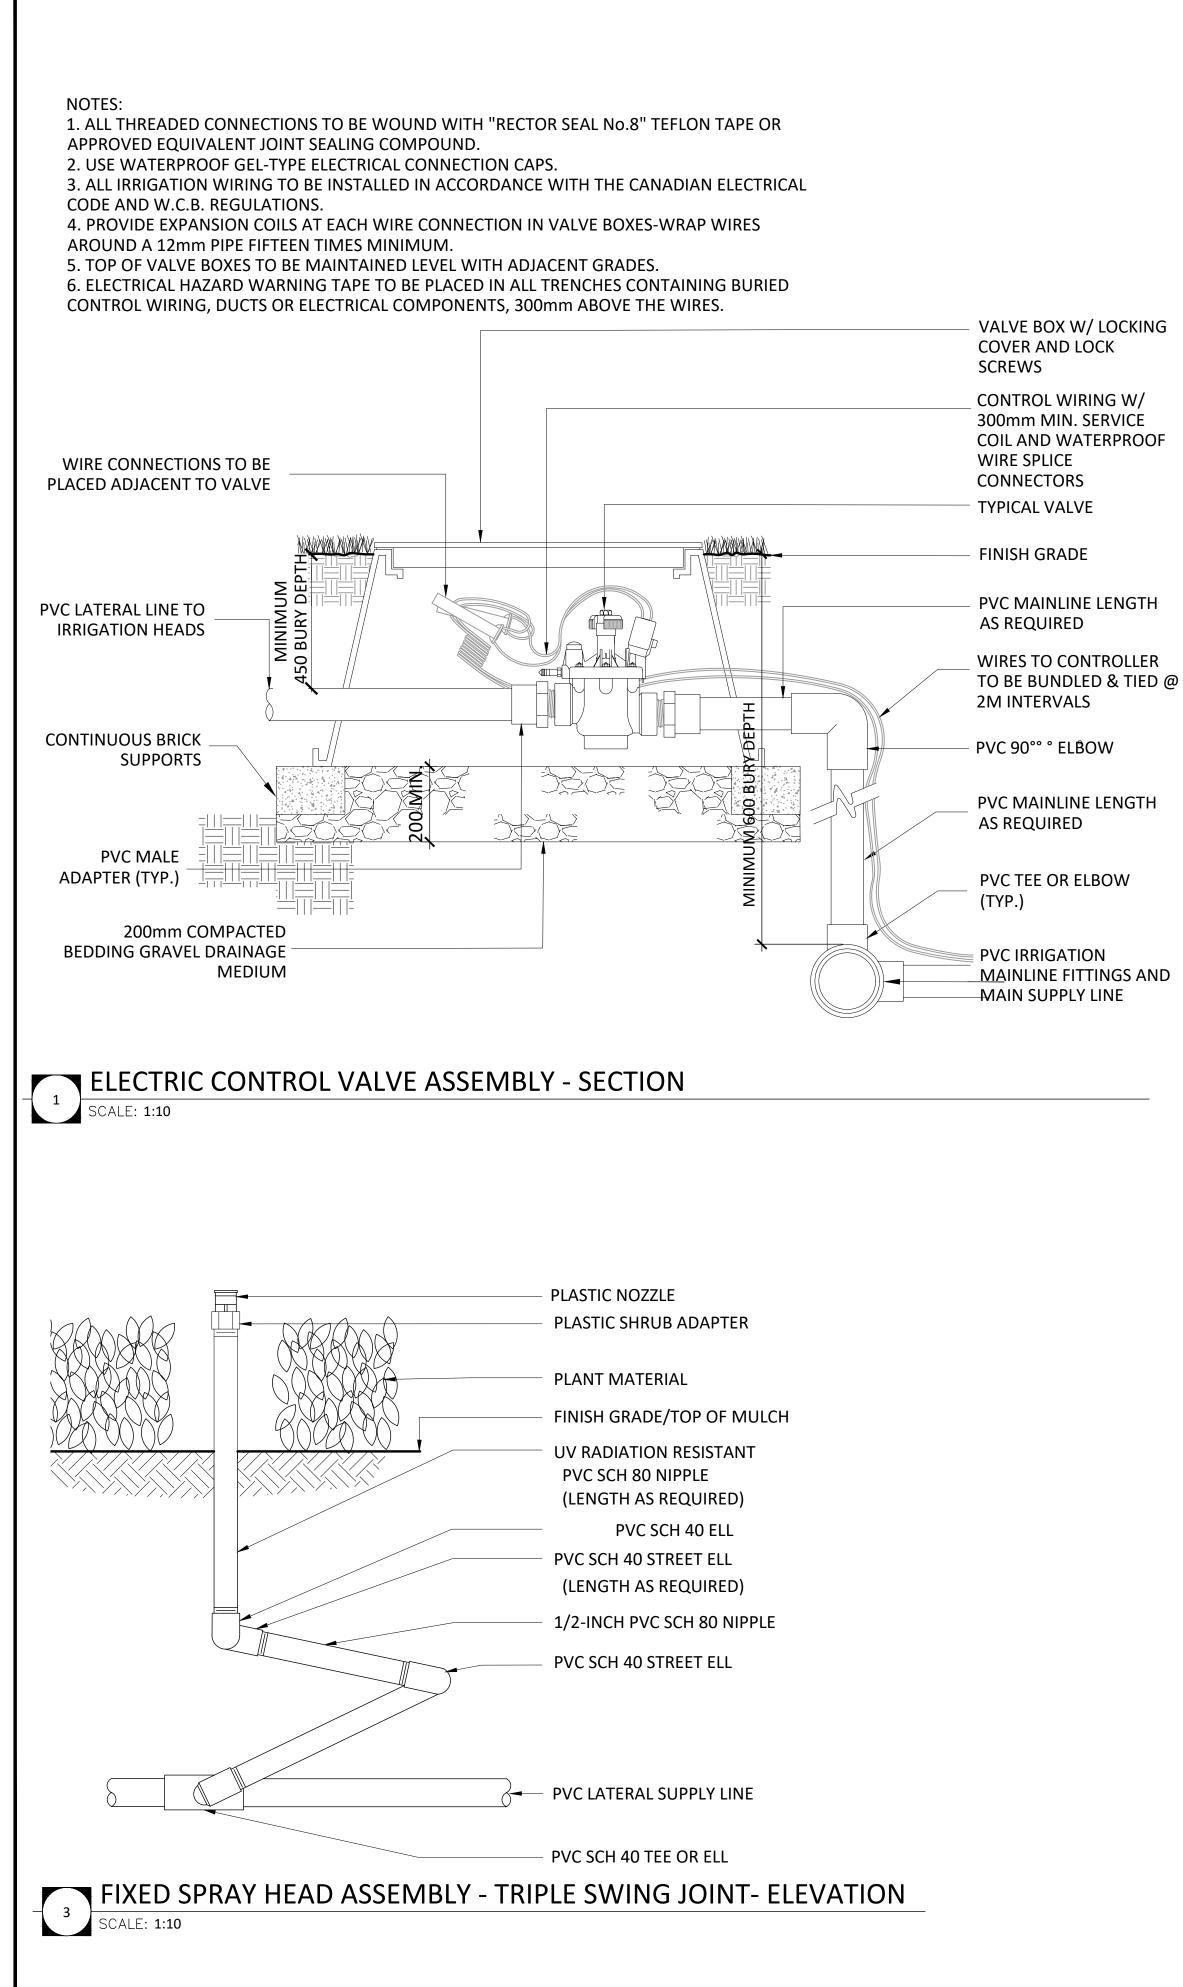IRRIGATION SYSTEM GENERAL NOTES:

1. ALL IRRIGATION MATERIAL, PRODUCTS AND INSTALLATION SHALL CONFORM TO THE IRRIGATION TECHNICAL SPECIFICATIONS, CONTRACT DRAWINGS, TOWN OF CANMORE ENGINEERING DESIGN AND CONSTRUCTION GUIDELINES, AND APPROVED SHOP DRAWINGS UNLESS DIRECTED OTHERWISE BY THE CONTRACT ADMINISTRATOR (CA) AND SHALL FOLLOW WHICHEVER SPECIFICATIONS ARE MORE STRINGENT. 2. THE CONTRACTOR SHALL NOTIFY THE CA OF ANY DISCREPENCIES BETWEEN SPECIFICATIONS PRIOR TO ANY WORK.

3. EXISTING IRRIGATION IS PROVIDED BY A RAINBIRD TURF BATTERY OPERATED SYSTEM (TBOS[®]) - BASED INSTALLATION, WITH ELEVEN (11) BATTERY-POWERED, BLUETOOTH CONTROLLED ZONES. WATER PRESSURE IS SET AT 500 - 550 kPa (75 - 80 PSI), WITH UP TO 700 kPa (100 PSI)

4. THE IRRIGATION CONTRACTOR SHALL PROVIDE RECOMMENDATIONS TO THE OWNER REGARDING SALVAGE AND RE-USE OF EXISTING IRRIGATION SYSTEM COMPONENTS, FOR INCORPORATION INTO THE NEW SYSTEM. 5. THE CONTRACTOR SHALL PROVIDE FULLY DETAILED AND SCALED SHOP DRAWINGS FOR APPROVAL BY THE CONTRACT ADMINISTRATOR (C.A.). 6. THE CONTRACTOR SHALL VERIFY THE LOCATION OF ALL EXISTING UNDERGROUND SERVICES AND UTILITIES PRIOR TO COMMENCING ANY

7. THE IRRIGATION PLANS ARE SCHEMATIC ONLY AND SUBJECT TO

8. WHENEVER POSSIBLE, IRRIGATION LINES ARE TO BE PLACED IN LAWN, PLANTING BEDS OR MULCHED AREAS ADJACENT TO ROADWAYS,

9. ALL IRRIGATION LINES SHALL BE TRENCHED AND BACKFILLED (NOT INSTALLED BY MECHANICAL PLOWING).

10. IRRIGATION LINES INSTALLED UNDER HARD SURFACES, INCLUDING ASPHALT OR CONCRETE SIDEWALKS OR ROADWAYS, SHALL BE SLEEVED WITH SCHEDULE 40 PVC PIPE DUCTS, SIZED MINIMUM TWO TIMES (2X) THE COMBINED DIAMETER OF ALL IRRIGATION PIPE OR WIRE IN DUCT. 11. ENDS OF DUCT PIPE SHALL BE STUFFED WITH FIBREGLASS INSULATION AFTER IRRIGATION PIPE OR CONTROL WIRING INSTALLATION TO PREVENT DEBRIS ENTRY AND MINIMIZE MOVEMENT.

12. ALL IRRIGATION LINES OR WIRING CROSSING SHALLOW UTILITIES SHALL BE DUCTED. IRRIGATION WIRING AND IRRIGATION PIPE MUST BE RUN IN

13. ALL BURIED IRRIGATION WIRING SHALL HAVE HAZARD WARNING TAPE INSTALLED IN TRENCH ABOVE THE WIRING.

14. ALL IRRIGATION PIPING SHALL BE PRESSURE-TESTED IN ACCORDANCE WITH THE SPECIFICATIONS AND IN THE PRESSENCE OF THE CA OR A DESINATED REPRESENTATIVE, PRIOR TO INSTALLATION OF IRRIGATION HEADS. TEST LATERAL LINES SEPARATELY FROM MAIN LINE.

15. IRRIGATION EQUIPMENT SHALL BE RAINBIRD[®], OR APPROVED EQUIVALENT WITH EQUAL OR BETTER OPERATING AND PERFORMANCE

16. IRRIGATION HEAD PLACEMENT SHALL BE CONFIGURED TO PROVIDE HEAD-TO-HEAD COVERAGE AT CONSISTENT SPACING, WITH MINIMAL OVERSPRAY ONTO SIDEWALKS AND PARKING AREAS.

17. OVERSPRAY ONTO HARD SURFACES, BUILDINGS OR OTHER SITE FEATURES ARE SUBJECT TO CA APPROVAL.

18. IRRIGATION HEAD LOCATION AND SPACING MAY BE ADJUSTED IN THE FIELD, WITH PRIOR APPROVAL OF THE CA, TO ENSURE ADEQUATE AND EVEN COVERAGE. PREVAILING WIND DIRECTION AND SURFACE FEATURES MUST BE TAKEN INTO ACCOUNT TO AVOID OVERSPRAY. SHOULD COVERAGE APPEAR UNSATISFACTORY UPON OPERATIONAL TESTING, ADJUSTMENTS TO SPACING SHALL BE CARRIED OUT TO THE SATISFACTION

19. ELECTRIC IRRIGATION ZONE CONTROL VALVES SHALL BE SIZED AND LOCATED FOR OPTIMUM COVERAGE AND SYSTEM OPERATION ON

20. ALL VALVES SHALL BE INSTALLED IN LIDDED VALVE BOXES, SIZED TO ACCOMMODATE VALVE(S) WITH ADEQUATE CLEARANCE AND WORKING ROOM. UP TO THREE (3) VALVES MAY BE CLUSTERED IN A SINGLE VALVE

21. IRRIGATION ZONES TO BE SEPARATED BASED ON PLANT MATERIAL

22. QUICK-CONNECT TURF VALVES IN VALVE BOXES SHALL BE LOCATED AT DESIGNATED POINTS ON THE MAINLINES.

23. MANUAL VALVE CONTROLLED STANDPIPES, WITH A STANDARD 19mm (¾") HOSE BIBB SPIGOT SHALL BE PROVIDED AT DESIGNATED POINTS ON

24. THRUST BLOCKS SHALL BE INSTALLED AS NEEDED AT MAINLINE

25. IRRIGATION HEAD AND VALVE BOX LOCATIONS SHALL BE STAKED OR INDICATED WITH SPRAY PAINT FOR APPROVAL OF THE C.A., PRIOR TO

26. TO THE DEGREE POSSIBLE, INSTALL VALVE BOXES IN CLUSTERS, IMMEDIATELY ADJACENT TO SIDEWALKS, WALKWAYS OR CURBS, FOR

27. EXISTING TREES, SIGNS, UTILITIES, LIGHT STANDARDS, HARD SURFACES OR OTHER FEATURES TAKE PRECEDENCE OVER IRRIGATION CONSTRUCTION. CONSULT CA FOR DIRECTION IN ALL CASES WHERE

28. IRRIGATION WATER SUPPLY CONNECTION TO WATER SOURCE SHALL BE WHERE INDICATED BY C.A. COMPLY WITH ALL REGULATIONS

CONCERNING CONNECTION TO POTABLE WATER SOURCES. 29. MINIMUM DEPTH OF BURIAL FOR IRRIGATION MAIN LINES: 450 MM. MINIMUM DEPTH OF BURIAL FOR IRRIGATION LATERAL LINES: 300 MM. 30. ALL ELECTRIC CONTROL WIRING SHALL BE #12AWG CONDUCTOR WIRE.

COMMON WIRE SHALL BE 10AWG CONDUCTOR. ONLY THE COMMON

31. CONTROL WIRING SPLICES SHALL BE MADE WITH 3M DBR/Y CONNECTORS AND MAY ONLY BE MADE AT ELECTRICAL CONTROL

32. PROVIDE MINIMUM 600 MM SLACK TWO-WIRE CABLES AT EACH ZONE VALVE OR CHANGE IN DIRECTION.

33. CONTROL WIRE RUNS AND SPARE WIRES SHALL BE CAPPED IN THE LAST

34. UPON COMPLETION OF INSTALLATION THE CONTRACTOR SHALL, IN THE PRESENCE OF THE CA, PROVIDE ON-SITE INSTRUCTION TO THE OWNER'S REPRESENTATIVE(S), AND ANSWER ANY QUESTIONS ABOUT THE SYSTEM



.andscape Architect: 509-318 Homer Street, Vancouver, British Columbia, Canada, V6B 2V Web: www.elac.ca Tel: (604) 899-3806 Email: info@elac.o

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Revisions

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ISSUED FOR TENDER NOT FOR CONSTRUCTION




Project


Client


CANMORE CEMETERY FINAL **DESIGN AND NEW** COLUMBARIUM

Drawing Title DETAILS IRRIGATION

Date OCTOBER, 2022	ELAC Project No. 21-816
Scale (On 22 x 34 Inch Sheet) As Noted	Drawing No.
Drawn By LB	L8.1
Checked HR	

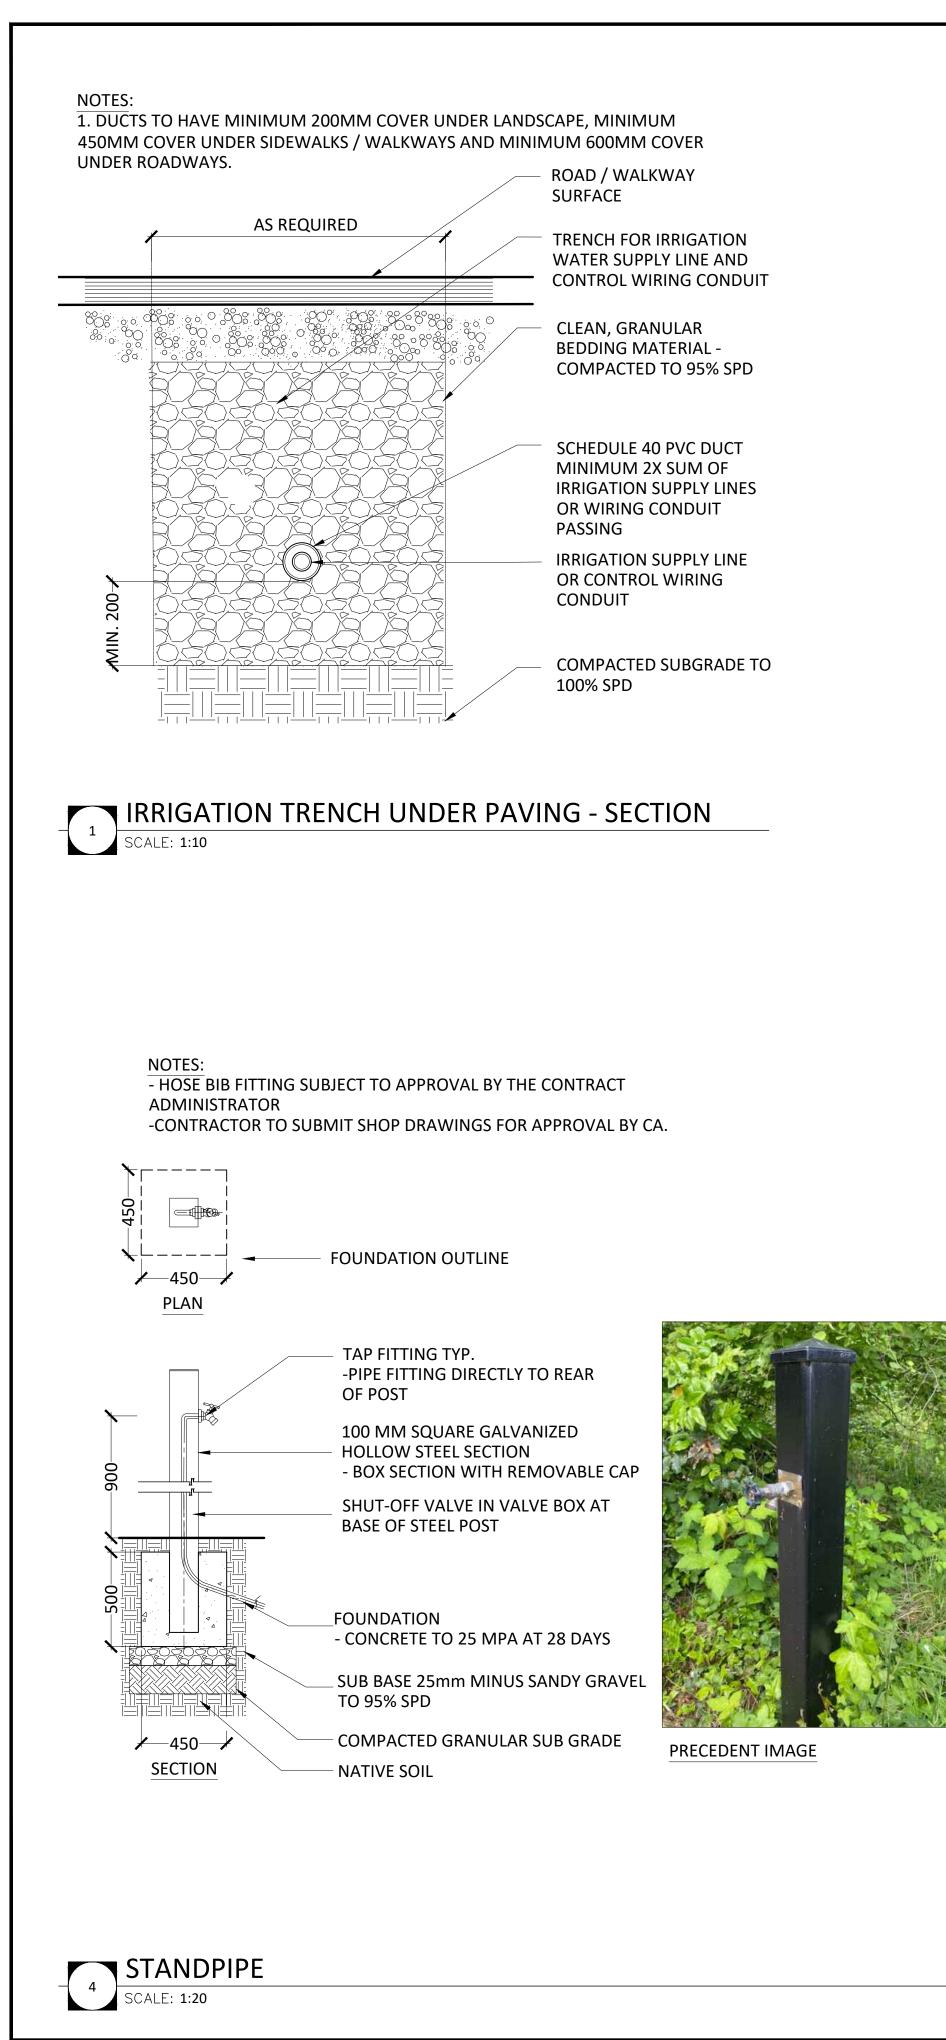


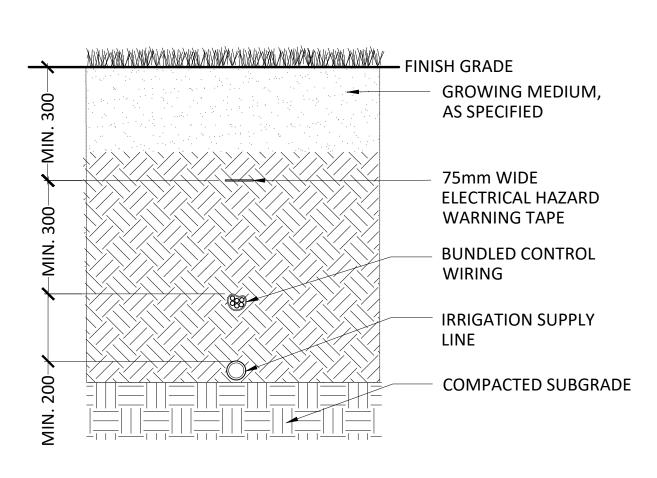

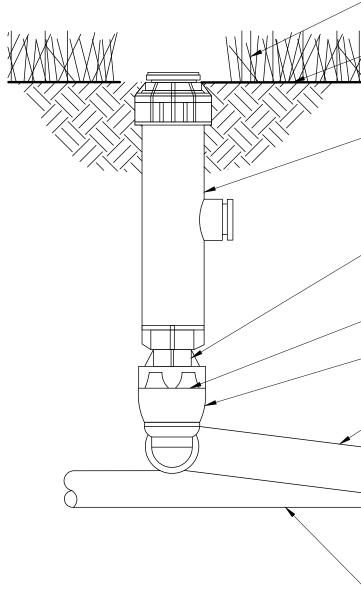

	TYPICAL TRENCH - SECTION
2	SCALE: 1:10

	 LAWN FINISH GRADE/ TOP OF MULCH POP-UP SPRAY SPRINKLER 	LAGSGSGSGS Landscape Architects 509-318 Homer Street Vancouver British Columbia Canada V6B 2V2 Tei: (604) 899-3806 Web: www.elac.ca Email: info@elac.ca COPYRIGHT RESERVED After payment of all outstanding invoices, ownership of the final versions of paymings, which cannot be used or reproduced without ELAC's written consent. Contractors shall verify and be responsible for all dimensions and conditions on the job. This office shall be informed of any discrepancies from the dimensions and conditions shown on the drawing. Revisions
	 PVC SCH 80 NIPPLE (LENGTH AS REQUIRED) PVC SCH 40 ELL PVC SCH 40 STREET ELL 1/2-INCH PVC SCH 80 NIPPLE (LENGTH AS REQUIRED) PVC SCH 40 STREET ELL PVC SCH 40 STREET ELL PVC SCH 40 TEE OR ELL PVC LATERAL SUPPLY LINE 	No.DateStatusBy1OCT. 21,2022ISSUED FOR 50% REVIEWLB2DEC. 9,2022ISSUED FOR 90% REVIEWLB3MAR. 24,2023ISSUED FOR TENDERLB4MAY 12,2023ISSUED FOR TENDER - UPDATELB
3 SCALE: 1:10	TION HEAD	
		<text><text><text><image/><text></text></text></text></text>
2 3 4	20 30 40 50 60 70 80 90 100mm	Drawing Title DETAILS IRRIGATIONDate OCTOBER, 2022ELAC Project No. 21-816Scale (On 22 x 34 Inch Sheet) As NotedDrawing No.Drawn By LBDrawing No.Checked HRL8.

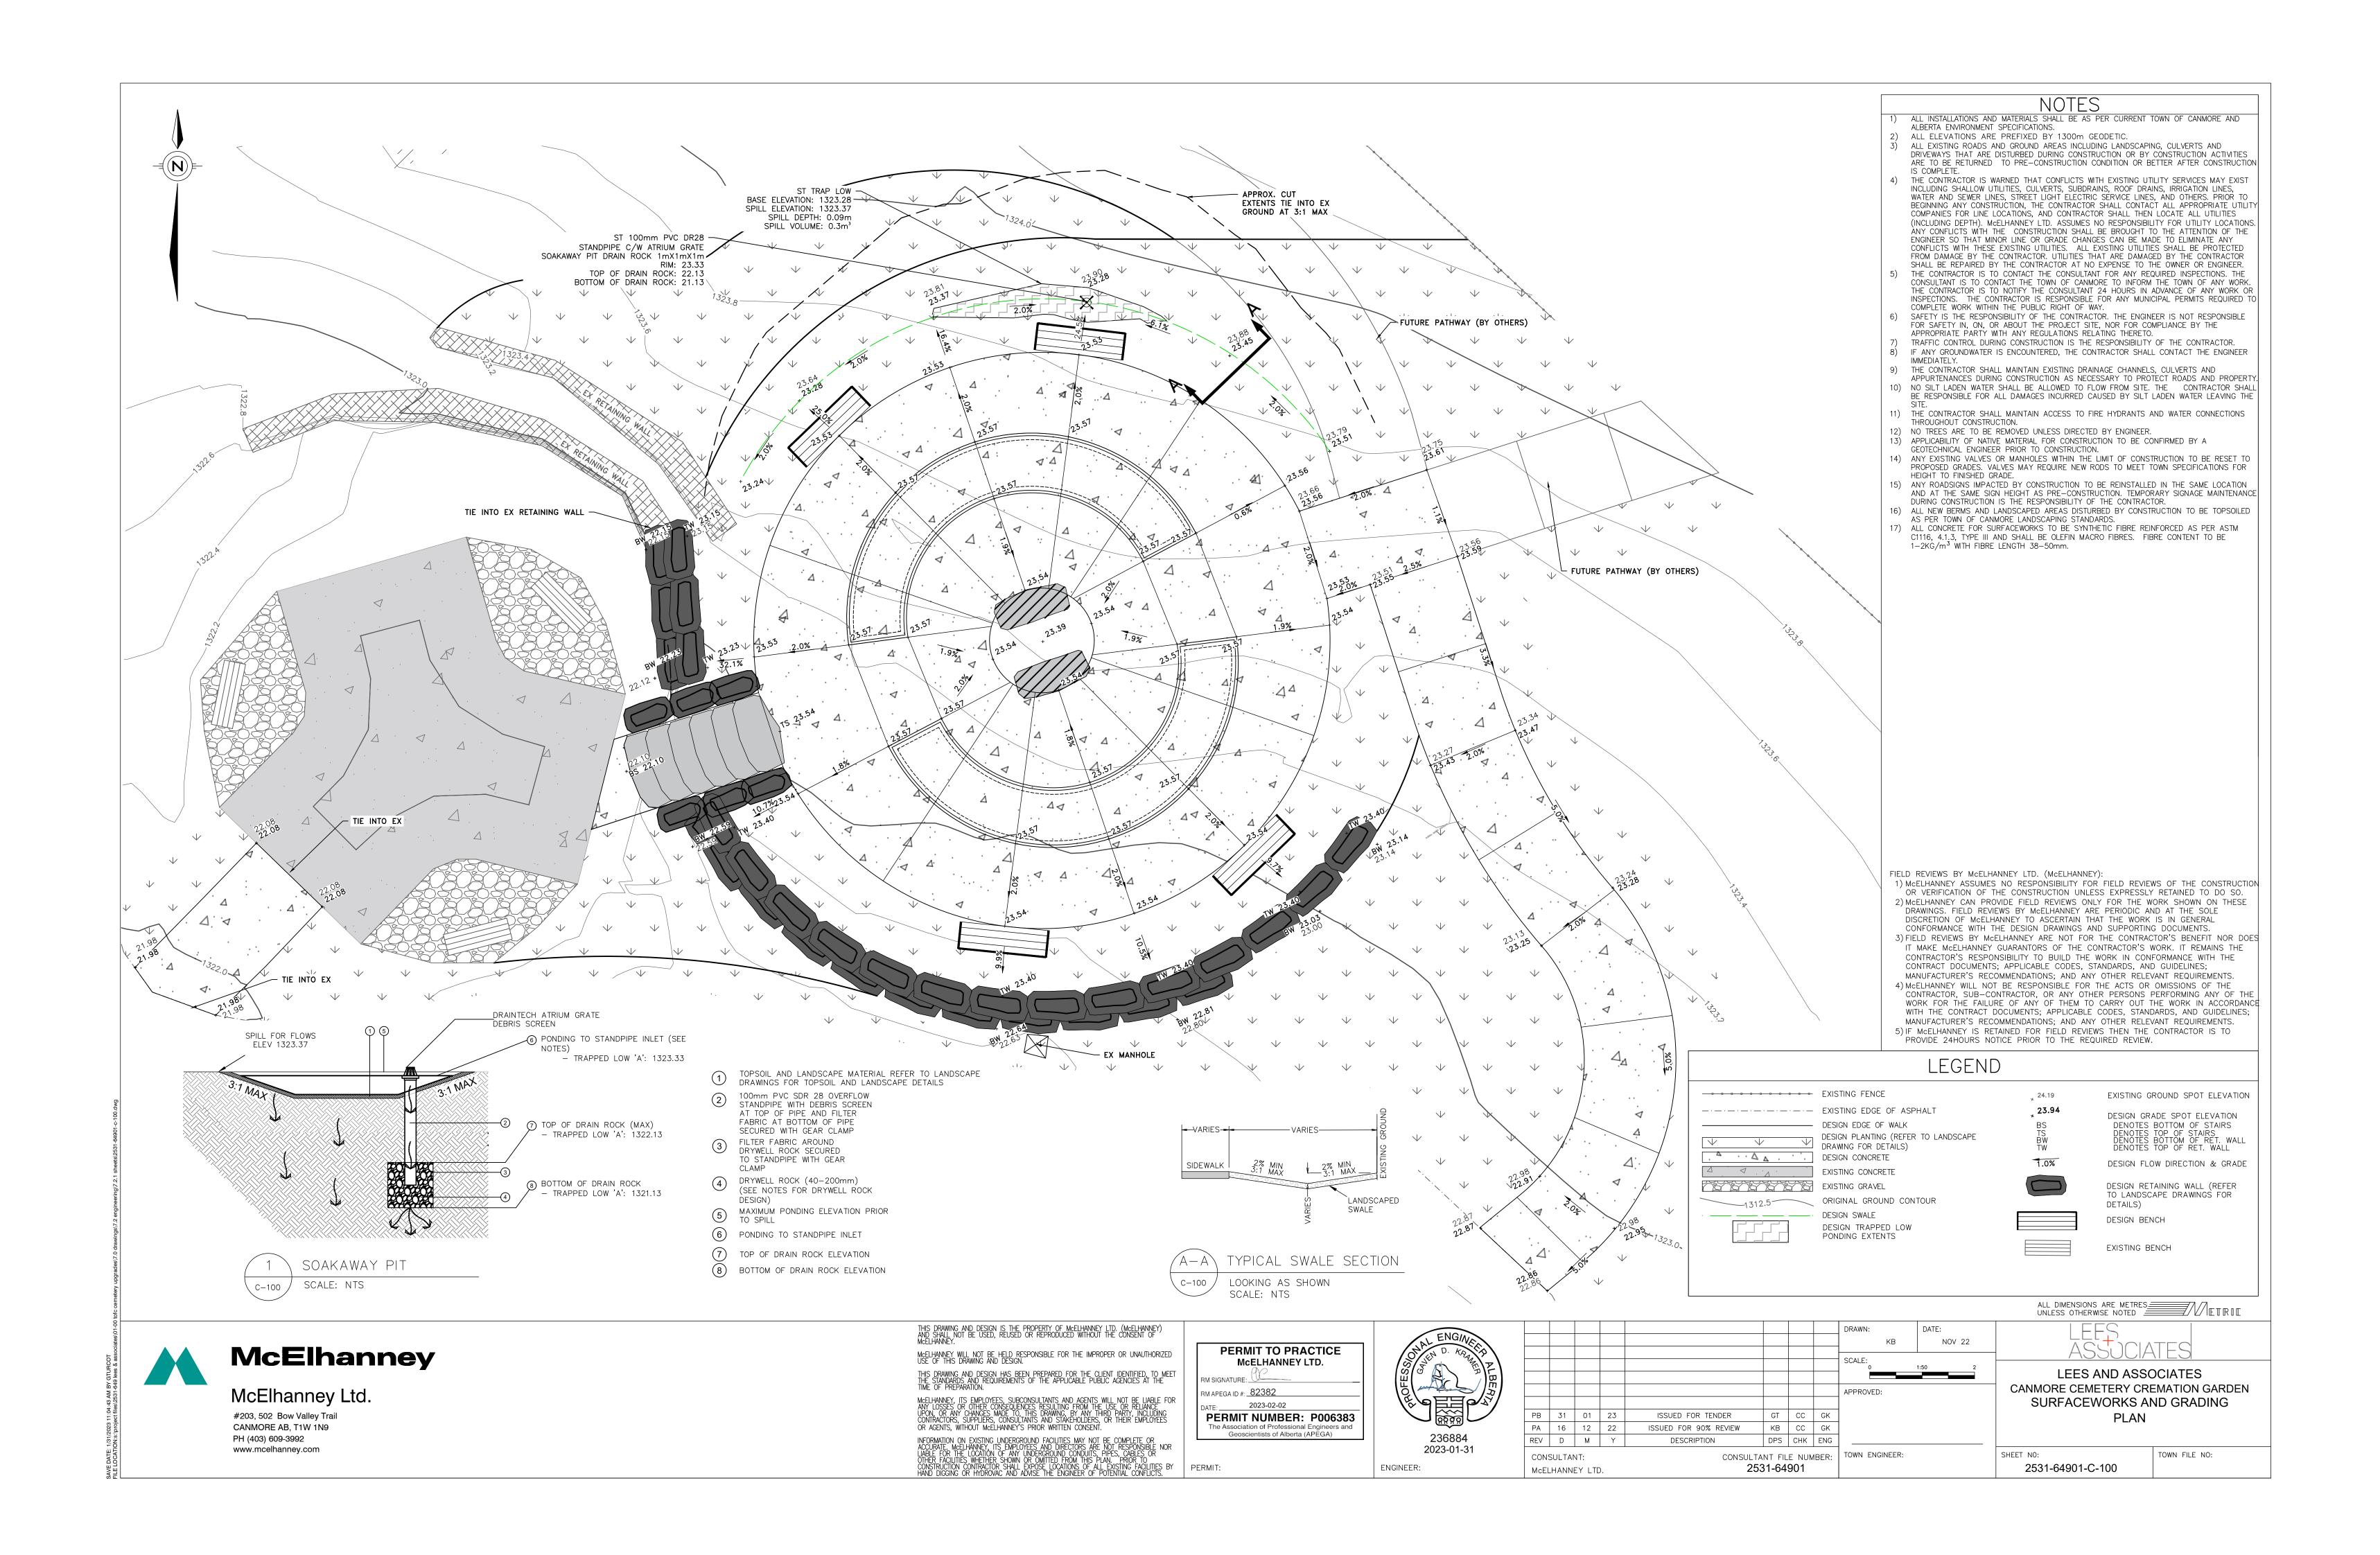

STRUCTURAL NOTES

GENERAL

- 1. ALL CONSTRUCTION IS TO CONFORM TO THE NATIONAL BUILDING CODE ALBERTA EDITION (2019).
- 2. ALL REFERENCES TO CONSTRUCTION STANDARDS NOTED ON THESE DRAWINGS REFER TO THE LATEST REVISED ISSUE.
- 3. THE DRAWING PREPARED BY MCELHANNEY LTD. (MCELHANNEY) ARE INTENDED FOR STRUCTURAL REQUIREMENTS OF THIS PROJECT ONLY. ALL OTHER ASPECTS ASSOCIATED WITH THIS PROJECT WHICH INCLUDE, BUT ARE NOT LIMITED TO, ARCHITECTURAL, CIVIL, GEOTECHNICAL, OCCUPANT SAFETY AND ACCESSIBILITY ARE TO BE DESIGNED, SPECIFIED AND APPROVED BY OTHERS AND ARE CONSIDERED BEYOND MCELHANNEY SCOPE OF WORK
- 4. STRUCTURAL ELEMENTS PRESENTED ON THESE DRAWINGS ARE FOR PERMANENT STRUCTURE AND FOUNDATIONS ONLY. THE CONTRACTOR IS RESPONSIBLE FOR ALL TEMPORARY AND CONSTRUCTION BRACING AND SUPPORT INCLUDING GEOTECHNICAL REQUIREMENTS UNTIL THE PROJECT IS COMPLETED.
- 5. REFER TO ARCHITECTURAL AND CIVIL DRAWINGS AND SPECIFICATIONS FOR DIMENSIONS, GRADES. ETC., GRADES, ELEVATIONS AND SLOPES SHOWN ON STRUCTURAL DRAWINGS ARE FOR REFERENCE ONLY AND MUST BE CONFIRMED WITH ARCHITECTURAL DRAWINGS AND/OR SITE CONDITIONS PRIOR TO CONSTRUCTION.
- 6. THE CONTRACTOR IS RESPONSIBLE FOR DIMENSIONS TO BE CONFIRMED AND CORRELATED AT THE JOB SITE, FOR INFORMATION THAT PERTAINS SOLELY TO FABRICATION PROCESSES OR TO TECHNIQUES OF CONSTRUCTION AND INSTALLATION AND FOR COORDINATION OF THE WORK OF ALL SUB-TRADES.

REFERENCED DRAWINGS

- 1. FOUNDATION LAYOUT AND STRUCTURAL SIZING IS BASED ON ARCHITECTURAL DESIGN DRAWINGS PREPARED BY LEES AND ASSOCIATES LANDSCAPE.
- 2. Mcelhanney has relied on the architectural drawing set as accurate and true. MCELHANNEY IS NOT RESPONSIBLE FOR ANY ERROR/OMMISSIONS ON THESE DRAWINGS AS A RESULT OF ERRORS OR SUBSEQUENT CHANGES TO THE ARCHITECTURAL DRAWING SET OR UNKNOWN SITE AND AS-BUILT CONDITIONS.
- 3. IF CHANGES ARE MADE TO THE LAYOUT OF THE STRUCTURES, OR SITE CONDITIONS VARY FROM ASSUMED, OR THE ASSUMED LOAD PATHS ARE ALTERED, THE ARCHITECT AND STRUCTURAL ENGINEER SHOULD BE NOTIFIED SUCH THAT CHANGES CAN BE MADE TO THE DESIGN IF REQUIRED.
- 4. McELHANNEY HAS ASSUMED THAT THE SUPPLIED SHED BUILDING WAS DESIGNED AND CONSTRUCTED TO BUILDING CODE REQUIREMENTS AT THE TIME OF CONSTRUCTION AND MCELHANNEY HAS NOT REVIEWED THE STRUCTURAL COMPETENCY OF THE SHED BUILDING STRUCTURE AS SUCH MCELHANNEY ACCEPTS NO RESPONSIBILITY FOR THE STRUCTURAL COMPETENCY AND STABILITY OF THE EXISTING STRUCTURE.

FIELD REVIEWS BY MCELHANNEY LTD.

- 1. McELHANNEY ASSUMES NO RESPONSIBILITY FOR FIELD REVIEWS OF THE CONSTRUCTION OR VERIFICATION OF THE CONSTRUCTION UNLESS EXPRESSLY RETAINED TO DO SO.
- 2. McELHANNEY LTD. (McELHANNEY) PROVIDE FIELD REVIEWS ONLY FOR THE WORK SHOWN ON THESE DRAWINGS. FIELD REVIEWS BY MCELHANNEY ARE PERIODIC AND AT THE SOLE DISCRETION OF MCELHANNEY IN ORDER TO ASCERTAIN THAT THE WORK IS IN GENERAL CONFORMANCE WITH THE DESIGN DRAWINGS AND SUPPORTING DOCUMENTS.
- 3. FIELD REVIEWS BY MCELHANNEY ARE NOT FOR THE CONTRACTORS BENEFIT NOR DOES IT MAKE MCELHANNEY GUARANTORS OF THE CONTRACTOR'S WORK. IT REMAINS THE CONTRACTOR'S RESPONSIBILITY TO BUILD THE WORK IN CONFORMANCE WITH THE CONTRACT DOCUMENTS.
- 4. McELHANNEY WILL NOT BE RESPONSIBLE FOR THE ACTS OR OMISSIONS OF THE CONTRACTOR, SUB-CONTRACTOR, OR ANY OTHER PERSONS PERFORMING ANY OF THE WORK OR FOR THE FAILURE OF ANY OF THEM TO CARRY OUT THE WORK IN ACCORDANCE WITH THE CONTRACT DOCUMENTS.
- 5. IF McELHANNEY IS RETAINED FOR FIELD REVIEWS THEN THE CONTRACTOR IS TO PROVIDE 24 HOUR NOTICE PRIOR TO CONCRETE POURS AND BEFORE ENCLOSING FRAMING ELEMENTS. FIELD REVIEWS ARE TO BE SCHEDULED AND TO BE CARRIED OUT DURING NORMAL BUSINESS HOURS UNLESS SPECIAL ARRANGEMENTS ARE MADE WITH MCELHANNEY.

DESIGN STANDARDS:

- 1. ALL STRUCTURAL COMPONENTS ARE TO BE DESIGNED AND FABRICATED IN ACCORDANCE WITH PART 4 OF THE NATIONAL BUILDING CODE - ALBERT EDITION (2019), CSA S16, CSA 086., TPIC PROCEDURES AND LOCAL BYLAWS
- 2. DESIGN LOADINGS: <u>SNOW</u> Ss = 3.2 kPa Sr = 0.1 kPa ls = 1.0 DEAD SHED = 42.3kN COLUMBARIUM = 127kN WIND 1/50 YEARS = 0.37kPa

SEISMIC DATA Sa (0.2) = 0.278 Sa (0.5) = 0.183 Sa (1.0) = 0.098 Sa (2.0) = 0.046 PGA = 0.128 SOIL SITE CLASSIFICATION = D le = 1.0

GEOTECHNICAL INFORMATION

lw = 1.0

- 1. REFER TO THE GEOTECHNICAL REPORT PREPARED BY TAYLOR GEOTECHNICAL LTD. (DATED AUGUST 16, 2022, GEOTECHNICAL INVESTIGATION FOR GREENFIELD PARCEL AT CANMORE CEMETERY PALISER TRAIL, CANMORE, AB, TGL FILE 2022-046) FOR SOIL CONDITIONS TO BE EXPECTED ON THIS SITE.
- 2. IT IS THE RECOMMENDATION OF MCELHANNEY LTD. THAT THE OWNER RETAIN A QUALIFIED GEOTECHNICAL ENGINEER TO MONITOR PILE INSTALLATION AND CONFIRM THE SUITABILITY OF THE ACTUAL GEOTECHNICAL CONDITIONS AND RECOMMENDATIONS FOR THIS PROJECT.

<u>CONCRETE</u>

1. PREPARATION, PLACING AND FINISHING OF CONCRETE IS TO CONFORM TO CSA A23.1.

2. TESTING OF CONCRETE IS TO CONFORM TO CSA A23.2. THE MINIMUM NUMBER OF TESTS IS NOT TO BE LESS THAN ONE (1) COMPRESSIVE STRENGTH, SLUMP AND AIR TEST FOR EACH CONCRETE ELEMENT (FOOTINGS, FOUNDATIONS AND SLABS). IN ADDITION: COMPRESSIVE STRENGTH TESTING FREQUENCY IS TO BE FOR ONE (1) TEST PER DAY


- FOR CONCRETE OF A SINGLE MIX DESIGN AND FOR EVERY 100 CUBIC METERS PLACED. AIR CONTENT TEST FREQUENCY FOR CONCRETE CLASSES F1, C-XL AND C1 IS TO BE ONE
- (1) TEST FOR EVERY LOAD OR BATCH
- 3. IT IS THE CONTRACTORS RESPONSIBILITY TO COORDINATE THE TESTING SCHEDULE AND TIMING WITH THE TESTING AGENCY.
- 4. IF A CONCRETE HARDENER IS SELECTED BY THE OWNER/ARCHITECT THEN THE AIR CONTENT OF THE CONCRETE IS TO BE COORDINATED WITH THE MANUFACTURER FOR COMPATIBILITY.


5. CON	CRETE PROPERTIES:	28 DAY	EXPOSURE			CEMENT	AGG.
	ITEM	STRENGTH	CLASS	W/C	AIR (%)	TYPE	SIZE (mm)
	FOOTINGS	25 Mpa	N	.55	4 - 7	GU	20
	FOUNDATIONS	25 Mpa	F-2	.55	4 - 7	GU	20
	INTERIOR SLAB	25 Mpa	Ν	.45	3 - 6	GU	20

						THIS DRAWING AND DESIGN IS THE PROPERTY OF MCELHANNEY LTD. (MCELHANNEY) AND SHALL NOT BE USED, REUSED OR REPRODUCED WITHOUT THE CONSENT OF MCELHANNEY.	THIS DRAWING IS PAP SHEETS WITHIN THE
						MCELHANNEY WILL NOT BE HELD RESPONSIBLE FOR THE IMPROPER OR UNAUTHORIZED USE	SHEET S100. THIS DRAWING IS INTI NOT INTENDED TO BE
						OF THIS DRAWING AND DESIGN. THIS DRAWING AND DESIGN HAS BEEN PREPARED FOR THE CLIENT IDENTIFIED, TO MEET THE STANDARDS AND REQUIREMENTS OF THE APPLICABLE PUBLIC AGENCIES AT THE TIME OF PREPARATION.	
							McELHANNEY RECOM ALL APPLICABLE DISC
						MCELHANNEY, ITS EMPLOYEES, SUBCONSULTANTS AND AGENTS WILL NOT BE LIABLE FOR	ELECTRICAL AND GEO
0	FEB 01, 2023	ISSUED FOR TENDER	JB	JB	SB	ANY LOSSES OR OTHER CONSEQUENCES RESULTING FROM THE USE OR RELIANCE UPON, OR ANY CHANGES MADE TO, THIS DRAWING, BY ANY THIRD PARTY, INCLUDING CONTRACTORS,	THE PROFESSIONAL S THIS PROJECT. OTHE
А	DEC 16, 2022	ISSUED FOR REVIEW	JB	JB	SB	SUPPLIERS, CONSULTANTS AND STAKEHOLDERS, OR THEIR EMPLOYEES OR AGENTS, WITHOUT McELHANNEY'S PRIOR WRITTEN CONSENT.	BY OTHERS AND IS N
Rev	Date	Description	Drawn	Design	App'd		


REINFORCING

- 1. REINFORCING STEEL IS TO CONFORM TO CSA G30.12M GRADE 400 MPa.
- 2. REINFORCING STEEL IS TO BE PLACED AS DETAILED TO 10mm TOLERANCE AND IS TO BE SUPPORTED BY PLASTIC SUPPORTS AND/OR HANGERS IN ACCORDANCE WITH CAN/CSA A23.1
- 3. LAP ALL REINFORCING BAR SPLICES 32 BAR DIAMETERS MINIMUM UNLESS INDICATED OTHERWISE ON THE DRAWINGS.
- 4. REINFORCING STEEL IS TO BE CLEAN, FREE OF CORROSION AND UNDAMAGED.
- 5. DO NOT WELD BARS OR USE HEAT TO BEND REINFORCING STEEL.
- 6. WELDED WIRE MESH IS TO CONFORM TO CSA G30.15.
- 7. CONCRETE COVER OVER REINFORCEMENT IS TO BE: a. SURFACE PLACED IN CONTACT WITH GROUND = 75mm b. FORMED SURFACE EXPOSED TO GROUND OR WEATHER =50mm

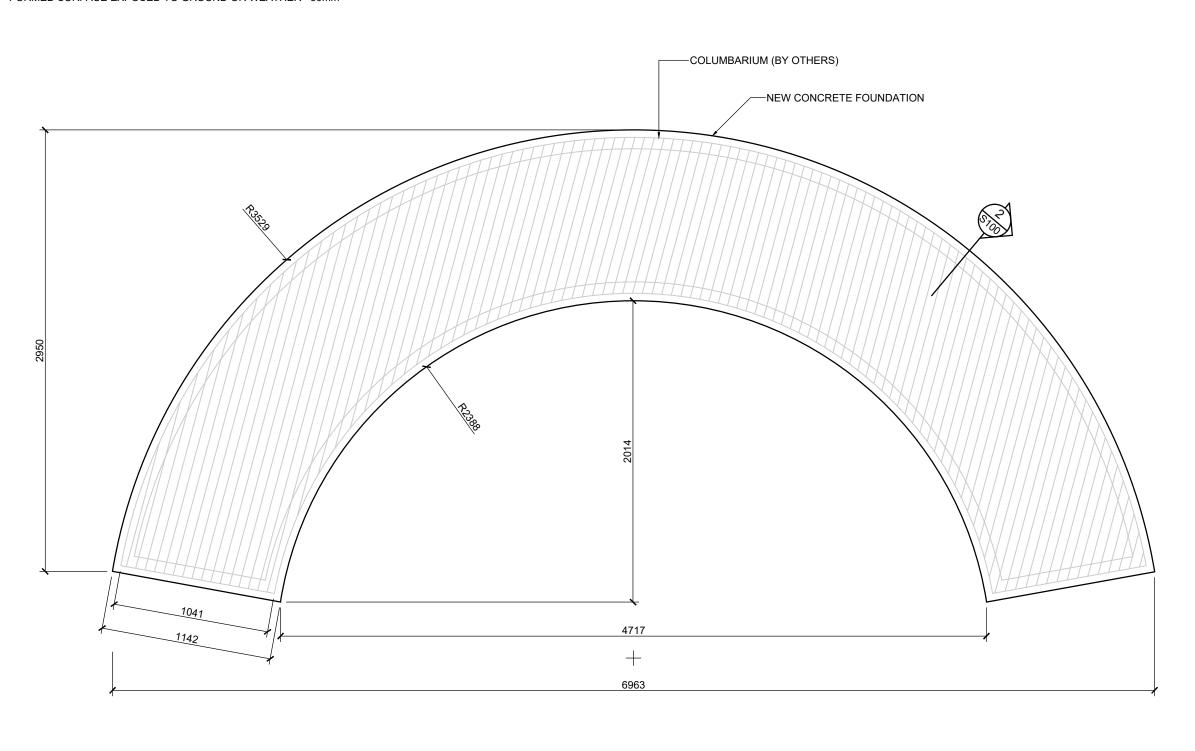


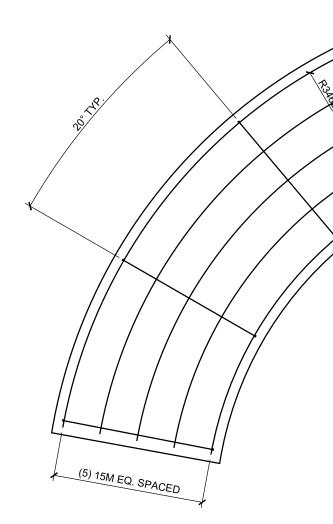




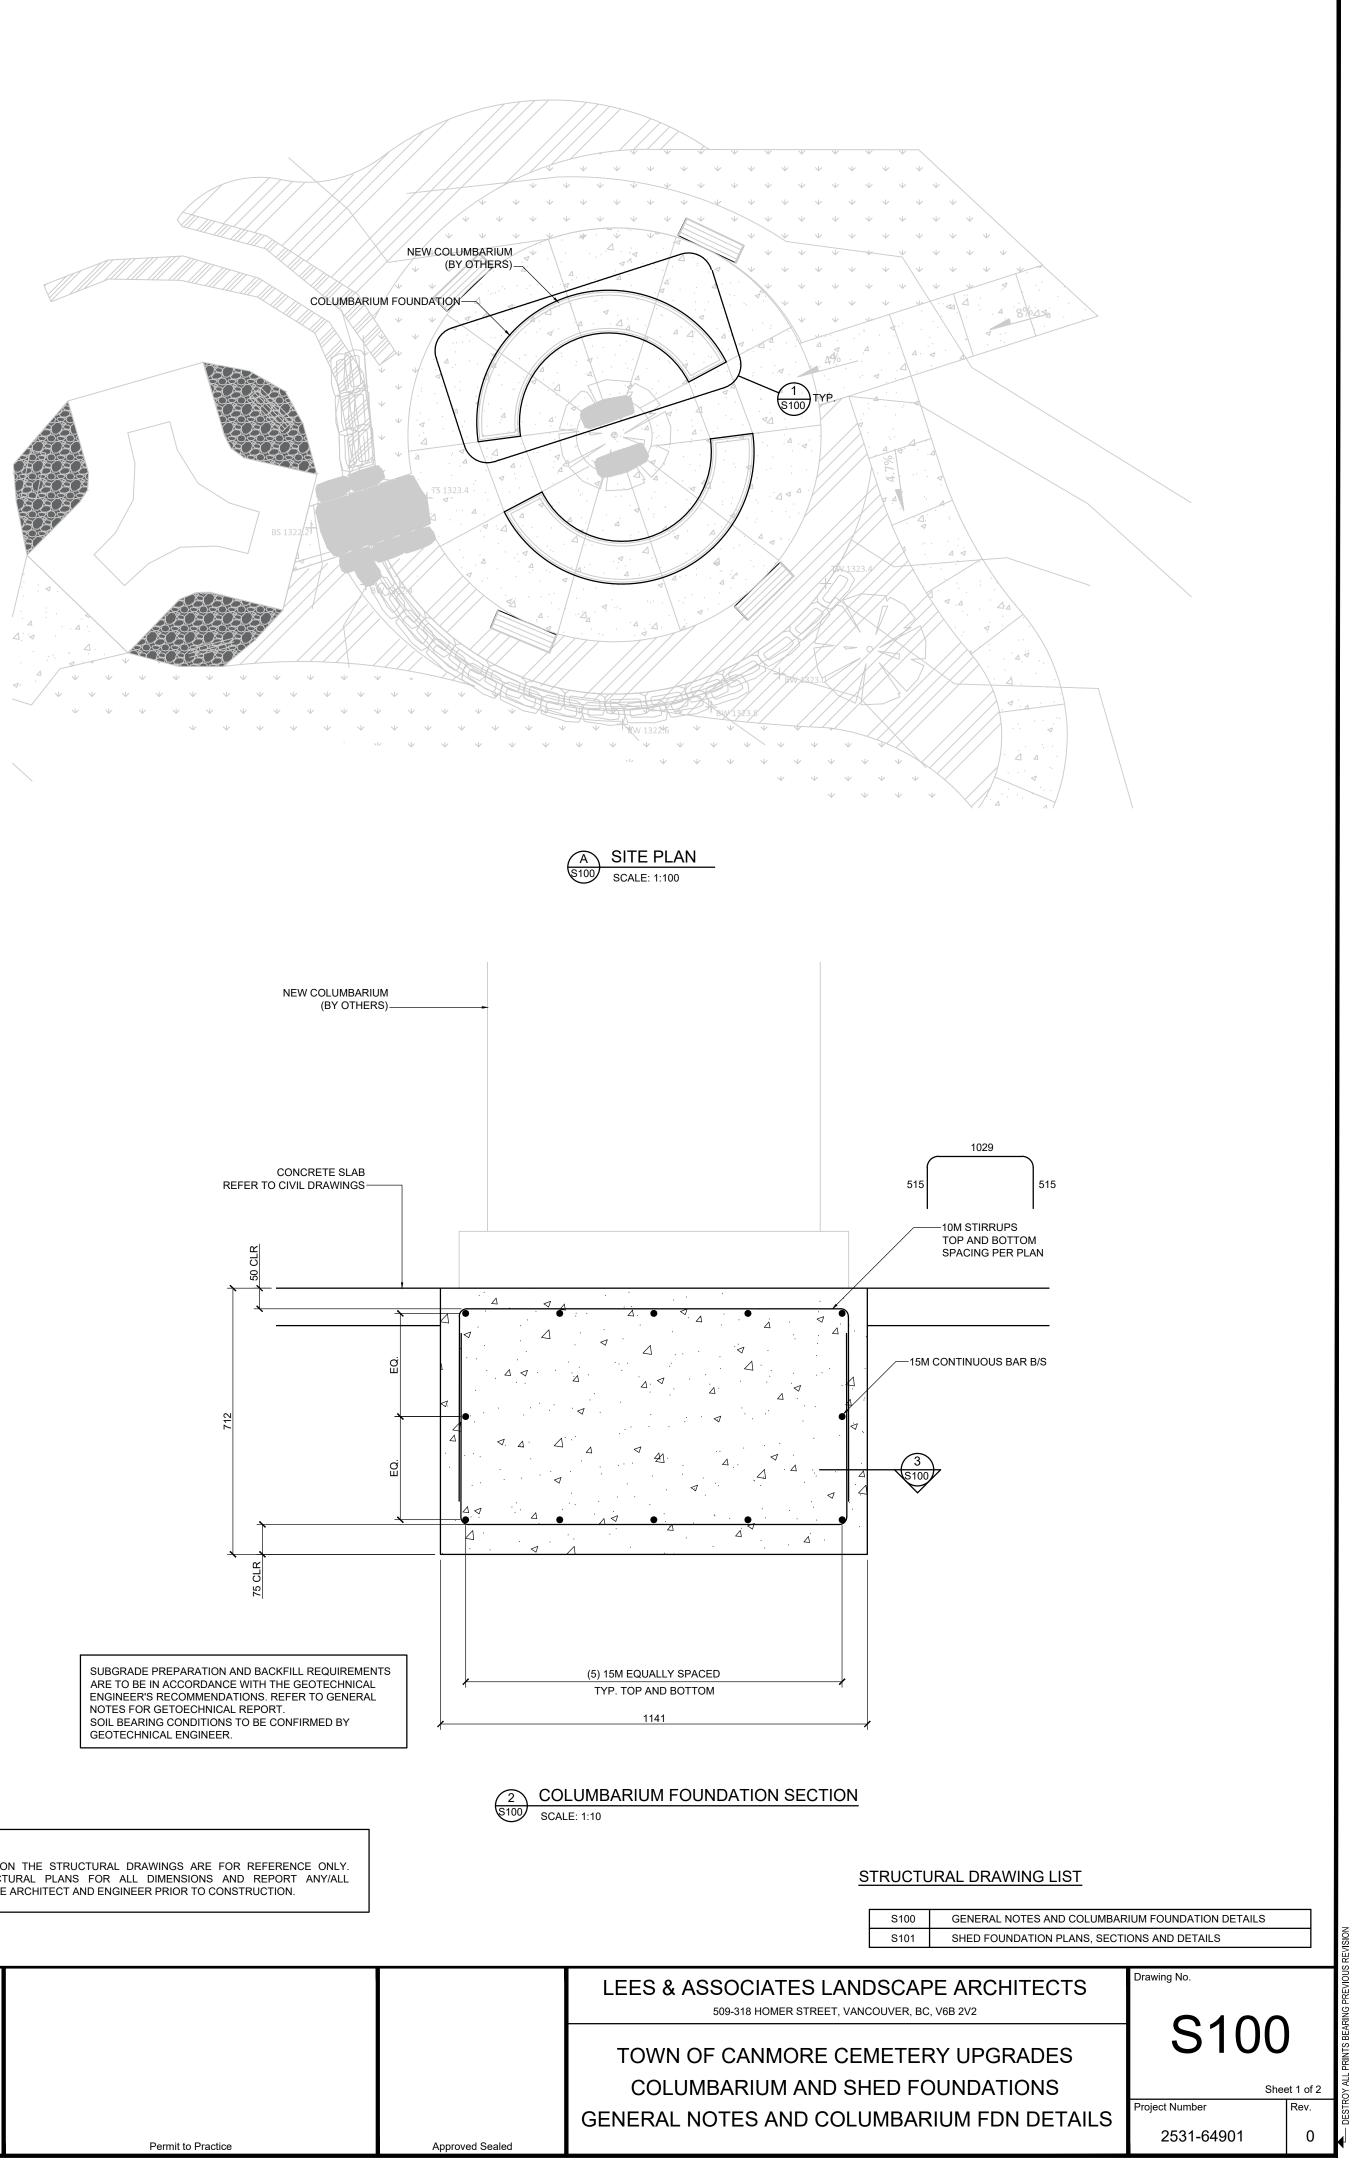

COLUMBARIUM FOUNDATION PLAN \$100 SCALE: 1:25

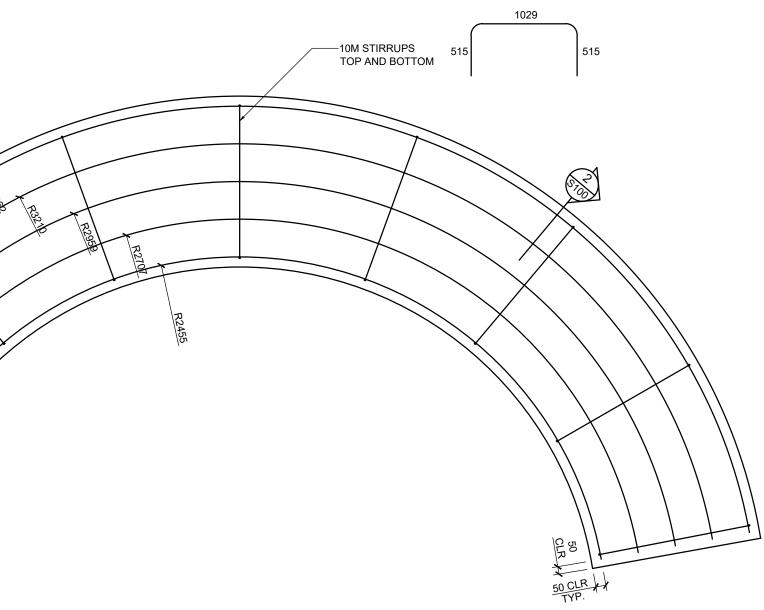

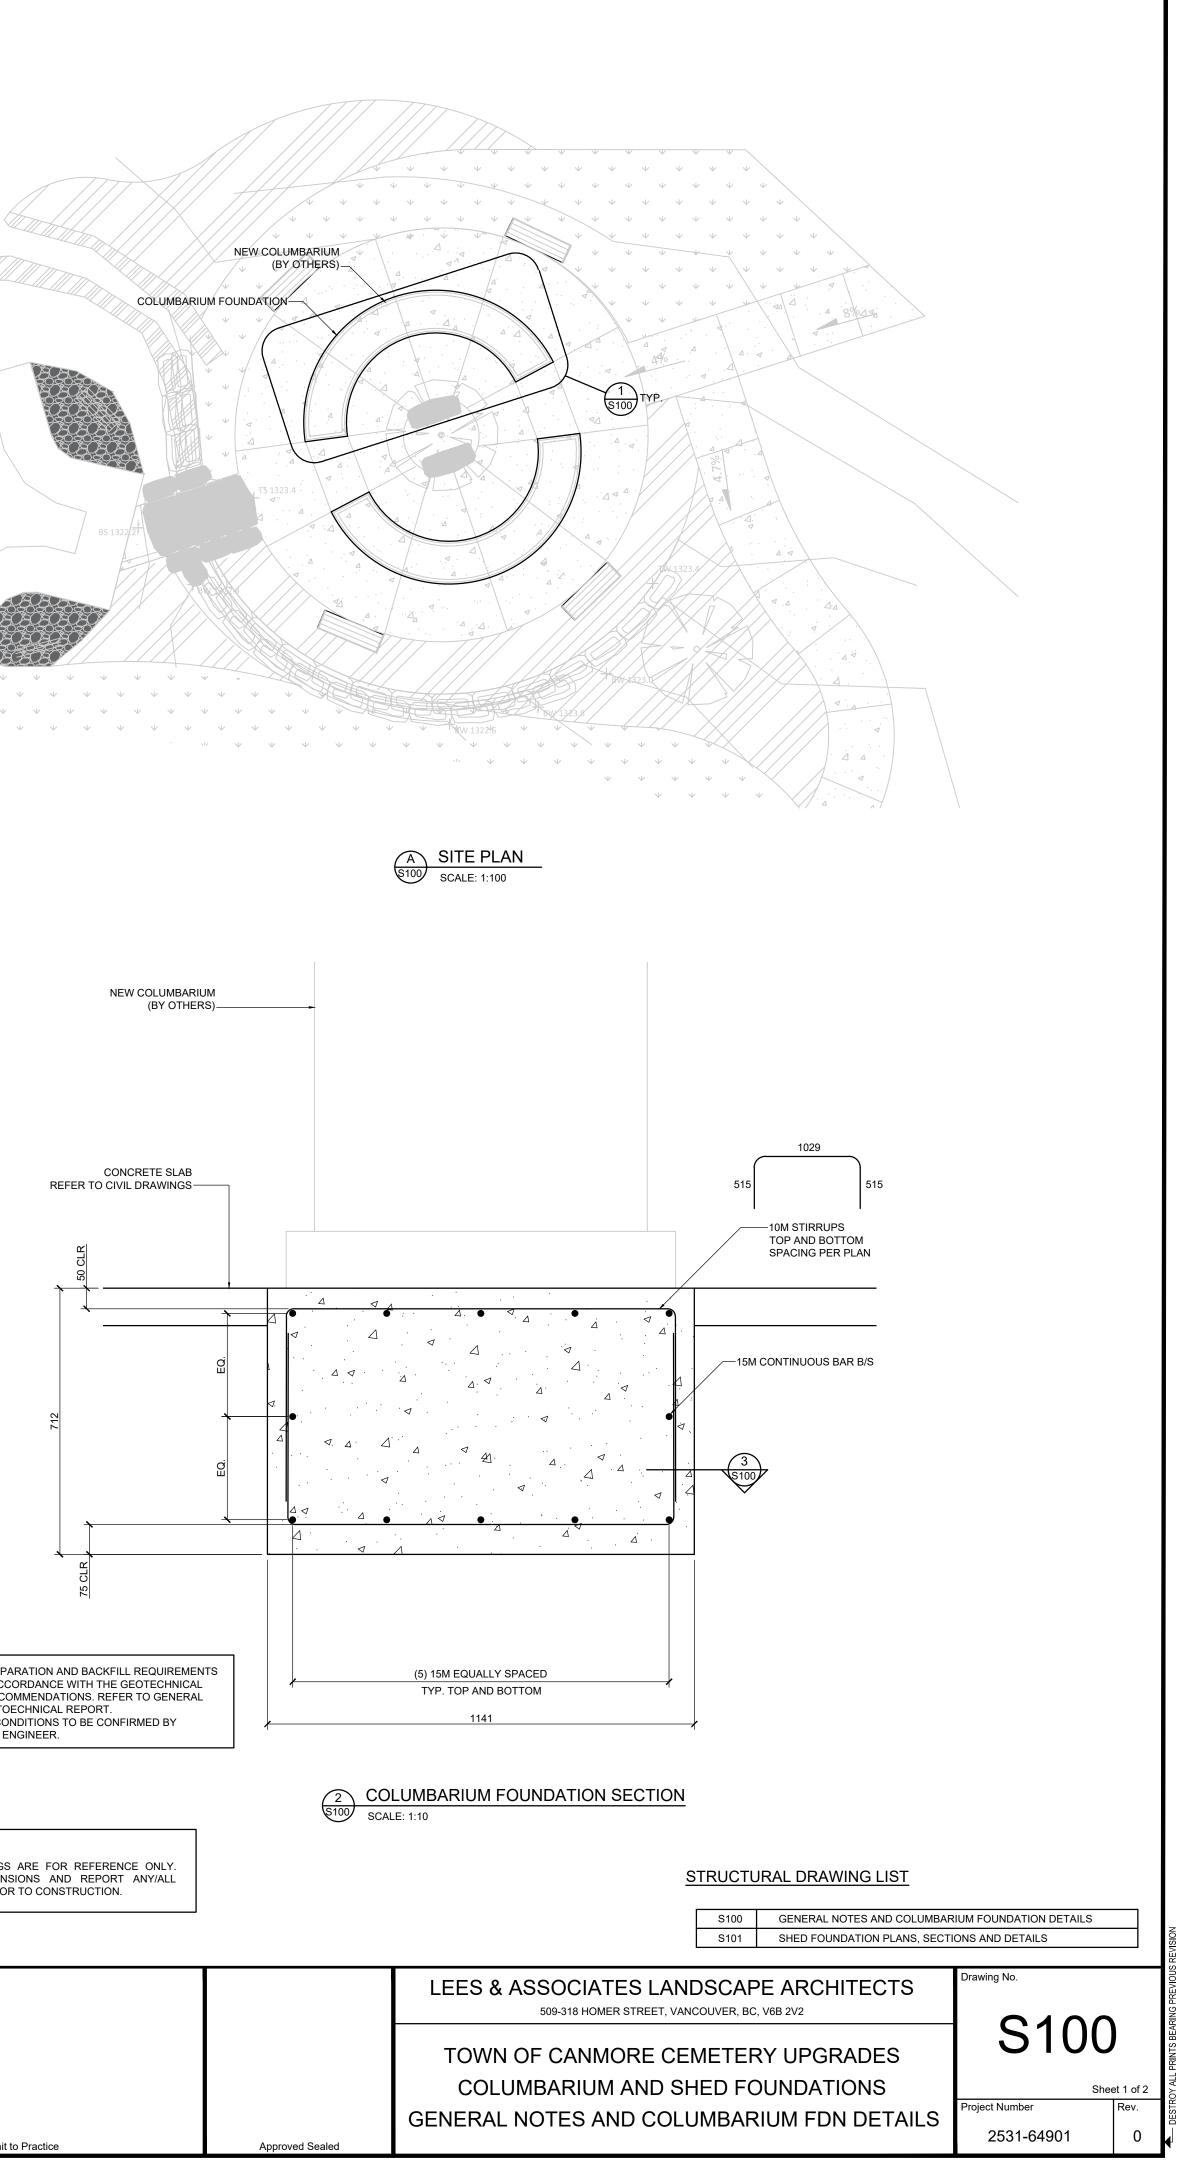

3 FOUNDATION REINFORCEMENT PLAN S100 SCALE: 1:25

CONTRACTOR'S NOTE:

DIMENSIONS SHOWN ON THE STRUCTURAL DRAWINGS ARE FOR REFERENCE ONLY. REFER TO ARCHITECTURAL PLANS FOR ALL DIMENSIONS AND REPORT ANY/ALL DISCREPANCIES TO THE ARCHITECT AND ENGINEER PRIOR TO CONSTRUCTION.

ART OF A COMPLETE SET OF DRAWINGS AND IS TO BE READ IN CONJUNCTION WITH ALL DRAWING SET. REFER TO ALL SHEETS INCLUDING STRUCTURAL NOTES PROVIDED ON ITENDED FOR THE STRUCTURAL CONSTRUCTION OF THIS PARTICULAR PROJECT AND IS BE USED AS A RECORD DRAWING UNLESS SPECIFICALLY NOTED AS SUCH. COMMENDS THE OWNER ENGAGES ALL PROFESSIONAL ASPECTS FOR THIS PROJECT FOR DISCIPLINES INCLUDING BUT NOT LIMITED TO: ARCHITECTURAL, CIVIL, MECHANICAL, EOTECHNICAL PROFESSIONS. L SEAL APPLIED TO THESE DRAWINGS APPLIES ONLY TO THE STRUCTURAL ASPECT OF HER ELEMENTS SHOWN ON THIS DRAWING IS FOR REFERENCE ONLY AND IS SPECIFIED NOT WITHIN THE SCOPE OF WORK OF BY McELHANNEY.

